

SR-71-18 / Revisn-Technology Park Transaction# 564577, AA#3968 City of Raleigh
Development Services Department
One Exchange Plaza
Raleigh, NC 27602
(919) 996-2495
DS.help@raleighnc.gov
www.raleighnc.gov

**LOCATION:** This site is located on the north side of Little Brier Creek Lane and west of the

intersection of Little Brier Creek Lane and Brier Creek Parkway. The site address is 10400 Little Brier Creek Lane and the PIN number is 0768274384.

**REQUEST:** Development of a 5.03 acre tract zoned Commercial Mixed Use that permits 3

stories in a Parkway Frontage (CX-3-PK). The applicant is proposing a 90,475 square foot building to accommodate hotel lodging and offices. The proposed

building includes 3 stories with a basement.

DESIGN ADJUSTMENT(S)/ ALTERNATES, ETC:

One Design Adjustment has been approved by the Development Services

Director Designee for this project, noted below:

Case DA-122-18. A Design Adjustment granting relief from the cross-access requirements. Existing topography impedes an offer to permit cross access to property along the eastern property line (PIN0768372507). Topography is a factor in UDO Section 8.3.1 D when deeming a design adjustment request

reasonable.

FINDINGS: City Administration finds that this request, with the below conditions of approval

being met, conforms to the Unified Development Ordinance. This approval is based on a preliminary plan dated 4/23/2019 by Patrick Barbeau of Timmons

Group.

## **CONDITIONS OF APPROVAL and NEXT STEPS:**

This document must be applied to the second sheet of all future submittals except for final plats. This is a preliminary plan and as such no permits have been issued with this approval. To obtain permits and/or completion of the project, the following steps are required:

☑ <u>CONCURRENT SITE REVIEW</u> - For land disturbance of 12,000 square feet or greater, public or private infrastructure, shared stormwater devices, etc. Concurrent Site Review may be submitted upon receipt of this signed approval document.

The following items are required prior to approval of Concurrent Site Review plans:

## **Engineering**

1. A right-of-way obstruction permit must be obtained from Right-of-way Services prior to the commencement of any construction activities within the right-of-way.

#### **Stormwater**

2. A 100-year floodplain analysis shall be submitted and approved by the Engineering Services Department prior to the issuance of any grading or site permit (UDO 9.3).



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- 3. The State of North Carolina shall approve any proposed disturbance within the riparian buffer prior to the issuance of any grading or site permit (UDO 9.2.3.E).
- 4. A stormwater control plan with a stormwater operations and maintenance manual and budget shall be approved (UDO 9.2).
- 5. A surety equal to of the cost of clearing, grubbing and reseeding a site, shall be paid to the City (UDO 9.4.4).

## **Urban Forestry**

- 6. Submit a final tree conservation plan that includes metes and bounds descriptions of all tree conservation areas and tree protection fencing as required (UDO 9.1.5).
- 7. Tree protection fence must be inspected by Urban Forestry staff prior to the issuance of a grading permit.

☑ <u>LEGAL DOCUMENTS</u> - Email to <u>legaldocumentreview@raleighnc.gov</u>. Legal documents must be approved, executed, and recorded prior to or in conjunction with the recorded plat on which the associated easements are shown. Copies of recorded documents must be returned to the City within one business day of recording to avoid withholding of further permit issuance.

	City Code Covenant	Slope Easement
$\boxtimes$	Stormwater Maintenance	Transit Easement
	Covenant	
$\boxtimes$	Utility Placement Easement	Cross Access Easement
	Sidewalk Easement	Public Access Easement
		Other:

⊠ <u>RECORDED MAP(S)</u> - Submit plat to record new property lines, easements, tree conservation areas, etc.). Plats may be submitted for review when the Concurrent Site Review plans, if required, have been deemed ready for mylar signature.

#### The following items must be approved prior to recording the plat:

#### General

- 1. Street names for this development shall be approved by the Raleigh GIS Division and by Wake County.
- 2. A Type C2 Street Protective Yard is required for this project and a note shall be placed on the final plat stating this requirement.

### **Engineering**

3. The required right of way for proposed and/or existing streets shall be dedicated to the City of Raleigh and shown on the map approved for recordation.



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- 4. A 5' general utility easement and associated deed of easement shall be approved by the City and the location of the easement shall be shown on the map approved for recordation. The deed of easement shall be recorded at Wake County Register of Deeds within one day of recordation of the recorded plat. A recorded copy of these documents must be provided to the Development Services Department within one day from authorization of lot recordation. If recorded copies of the documents are not provided, further recordings and building permit issuance will be withheld.
- 5. A sight distance easement will need to be recorded on the plat for the area of the sight distance triangle that leaves the public right-of-way and enters private property for the shown left turn sight distance at the proposed driveway.

#### Stormwater

- 6. A payment equal to twenty-four percent (24%) of the estimated cost of constructing all stormwater control facilities shown on the development plans shall be paid by the developer to the City stormwater facility replacement fund (UDO 9.2.2.G.3).
- 7. The flood prone areas, as approved by the City Stormwater Engineer and shown on the preliminary plan, shall be shown on the recorded map (UDO 9.3.3.G).
- 8. The City form document entitled Declaration of Maintenance Covenant and Grant of Protection Easement for Stormwater Control Facilities shall be approved by the City and recorded with the county register of deeds office (UDO 9.2.2.G).
- 9. All stormwater control measures and means of transporting stormwater runoff to and from any nitrogen and stormwater runoff control measures shall be shown on all plats for recording as private drainage easements (UDO 9.2).
- 10. The riparian buffers, in accordance with the preliminary plan and the State of North Carolina regulations, shall be shown on plats for recording along with required buffer statement (Recorded Map Checklist).
- 11. A surety equal to 125% of the cost of the construction of a stormwater device shall be paid to the Engineering Services Department (UDO 9.2.2.D.1.d).

## **Urban Forestry**

12. A tree conservation plat shall be recorded with metes and bounds showing the designated tree conservation areas (UDO 9.1). This development proposes 0.8 acres of tree conservation area.

⊠ <u>BUILDING PERMITS</u> – For buildings and structures shown on the approved plans. Commercial building permit plans must include the signed, approved Concurrent Site Review plans attached, if applicable. Permit sets may be reviewed prior to the recordation of required plats, but cannot be approved.



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#### The following items must be approved prior to the issuance of building permits:

#### General

- 1. Provide fire flow analysis.
- 2. A Type C2 Street Protective Yard is required for this project and a note shall be placed on the final plat stating this requirement.

## **Engineering**

- 3. A fee-in-lieu for 1' of sidewalk across the entire length of the property's frontage shall be paid to the City of Raleigh (UDO 8.1.10).
- 4. A right-of-way obstruction permit shall be obtained from Right-of-way Services for any construction activity within the right-of-way.

#### **Stormwater**

- 5. A payment equal to twenty-four percent (24%) of the estimated cost of constructing all stormwater control facilities shown on the development plans shall be paid by the developer to the City stormwater facility replacement fund (UDO 9.2.2.G.3).
- 6. The City form document entitled Declaration of Maintenance Covenant and Grant of Protection Easement for Stormwater Control Facilities shall be approved by the City and recorded with the county register of deeds office (UDO 9.2.2.G).
- All stormwater control measures and means of transporting stormwater runoff to and from any nitrogen and stormwater runoff control measures shall be shown on all plats for recording as private drainage easements (UDO 9.2).
- 8. A surety equal to 125% of the cost of the construction of a stormwater device shall be paid to the Engineering Services Department (UDO 9.2.2.D.1.d).

#### **Urban Forestry**

- 9. A tree conservation plat shall be recorded with metes and bounds showing the designated tree conservation areas (UDO 9.1).
- 10. A tree impact permit must be obtained for the approved streetscape tree installation in the right of way. This development proposes 18 street trees along Little Brier Creek Ln.

## The following are required prior to issuance of building occupancy permit:

1. All Water, Sanitary Sewer and Reuse facilities shall be installed, inspected, tested and accepted by the City of Raleigh Public Utilities Department for operations and maintenance.



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- 2. Required public right-of-way infrastructure improvements shall be, at a minimum, sufficiently completed to provide the necessary, safe emergency and vehicular access.
- Required underground storm drainage improvements shall be completed and as-built plan(s) and certification(s) reviewed and accepted by the City of Raleigh Development Services - Development Engineering program.
- All street lights and street signs required as part of the development approval are installed.
- 5. Copies of certified inspection reports for alleys and internal access ways are submitted to the City of Raleigh Development Services – Development Engineering program.
- 6. As-built drawings and associated forms for all Stormwater devices are accepted by the Engineering Services Department (UDO 9.2.2.D.3).
- 7. Final inspection of all tree conservation areas and right of way street trees by Urban Forestry Staff.

EXPIRATION DATES: The expiration provisions of UDO Section 10.2.8 E, including the ability to request extensions in the expiration date, apply to this site plan. If significant construction has not taken place on a project after administrative site review approval, that approval may expire and be declared void, requiring reapproval before permits may be issued. To avoid allowing this plan approval to expire the following must take place by the following dates:

3-Year Expiration Date: 5-29-2022

Obtain a valid building permit for the total area of the project, or a phase of the project.

4-Year Completion Date:

Within four years after issuance of the first building permit for the site plan, the construction of the entire site plan must be completed unless an applicant has been granted vested rights. Failure to complete construction within this specified time frame shall automatically void the approved site plan for which no building permits have been issued.

fit hit

I hereby certify this administrative decision.

Signed: (Development Services Dir./Designee)

Revisn-Technology Park: SR-71-18, Transaction# 564577, AA#3968

Staff Coordinator: Daniel L. Stegall

Date: 5/29/19

## Design Adjustment Staff Response



Per Section 10.2.18.C of the Unified Development Ordinance, the Development Services Director, or designee, shall consult with the heads of other City Departments regarding the review of the request. The Development Services Director, or designee, shall approve, approve with conditions or deny the request, but must do so within 60 days of the receipt of a completed application. Additional time may be necessary if a municipal or state entity is incorporated in the review process or if a detailed engineering study is submitted in conjunction with the request.

	Project Name	REVISN - To	echr	nology Park
IECT	Development Case Number	SR-71-18		
PROJECT	Transaction Number	564577		
	Design Adjustment Number	DA - 122	- 201	18
	Staff recommendation based upon t	he findings in	n the	applicable code(s):
	UDO Art. 8.3 Blocks, Lots, Acce			UDO Art. 8.5 Existing Streets
	UDO Art. 8.4 New Streets			Raleigh Street Design Manual
	Staff SUPPORTS DOES NOT SUPP	ORT th	e de	sign adjustment request.
		DEPART	MEI	VTS
	Dev. Services Planner			City Planning
	✓ Development Engineering			Transportation
	Engineering Services			Parks & Recreation and Cult. Res.
SF	Public Utilities			,
NO	CONDITIONS:			
STAFF RESPONSE				
Dev	elopment Services Director or Desig	nee Action:	<b>V</b>	APPROVE APPROVE WITH CONDITIONS DENY
				5/9/19
Auth	orized Signature			Date

\*The Development Services Director may authorize a designee to sign in his/her stead. Please print name and title next to signature. Appeal of the decision from the Development Services Director, or his or her designee, shall be made in writing within 30 days to the Board of Adjustment (see Section 10.2.18.C3b).

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## Staff Response Article 8.3 Blocks Lots, Access



The Development Services Director may in accordance with *Sec. 10.2.18.* approve a design adjustment, subject to all of the following findings.

A.	The requested design adjustment meets the intent of this Article;
	YES NO NO
В.	The requested design adjustment conforms with the Comprehensive Plan and
	adopted City plans;
	YES NO _
C.	The requested design adjustment does not increase congestion or compromise
	Safe <u>ty;</u>
	YES NO _
D,	The requested design adjustment does not create any lots without direct street
	Frontage;
	YES NO _
Ε,	The requested design adjustment is deemed reasonable due to one or more of the
	following:
	1. Topographic changes are too steep;
	2. The presence of existing buildings, stream and other natural features;
	3. Site layout of developed properties;
	4. Adjoining uses or their vehicles are incompatible;
	5. Strict compliance would pose a safety hazard; or
	6. Does not conflict with an approved or built roadway construction project
	7. adjacent to or in the vicinity of the site.
	YES NO NO
T/	AFF FINDINGS
Staf	f supports the request as it pertains to relief from the required offer of cross access to the property to
1e (	east (PIN 0768372507). Along the eastern property line, a 14' retaining wall has been designed due to existing topography which impedes an offer. Also, there exists wetlands and a blue line stream in the
nm	rediate area that would be negatively effected if an offer of cross access were to be offered.

## Design Adjustment Application



The purpose of this request is to seek a Design Adjustment from the Development Services Director, or designee, for a specific project only and, if granted, may be approved with special conditions and provisions. This application and all further action shall be consistent with Section 10.2.18 in the Unified Development Ordinance (UDO). The consideration and decision of this request shall be based solely on the conformance of the findings, as outlined in Sec. 8.3.6, Sec. 8.4.1.E and Sec. 8.5.1.G of the UDO or the Raleigh Street Design Manual.

					·		
b	Project Name REVISN - Technology Park						
PROJECT	Case Number SR-71-18						
PR	Transaction Number 564577						
æ	Name CIP BRIER CREEK LLC						
N	Address 111 E HARGETT ST, STE 300 City RALEIGH  State NC Zin Code 27601 Phone						
Ó	State NC	<b>Zip Code</b> 27601		Phone			
ט	Name Patrick Barbeau, PE		Firm Timn	nons Group			
CONTACT	Address 5410 Trinity Rd, Ste 10	2		City Raleigh	THE DESCRIPTION OF THE PROPERTY OF THE PROPERT		
8	State NC	<b>Zip Code</b> 27607		Phone 919-	866-4951		
	l am seeking a Design Adjustment	from the requirem	ents set forti	in the follow	ing:		
	UDO Art. 8.3 Blocks, Lots, Acces	<u>\$</u>	- See page 2	for findings			
	UDO Art. 8.4 New Streets		- See page 3	for findings			
	UDO Art. 8.5 Existing Streets		- See page 4	for findings			
ST	Raleigh Street Design Manual		- See page 5	for findings			
REQUEST	Provide details about the request;	(please attach a m	emorandum	if additional s	pace is needed):		
Applic By \$16	requirements: Neuse Riparian Buffer alor property; existing buildings (apartment be the responsibility of the applicant to provi- cant must be the Property Owner.	uildings) on the reside  de all pertinent infor  vledge the informa	ntial property. mation needed	for the conside	ration of this request.		
\Ø₩ne	er/Owner's Representative Signature	:			Date		
CHE	CKLIST						
	ed Design Adjustment Application				✓ Included		
	(s) addressing required findings				✓ Included		
Plan(	s) and support documentation			***************************************	✓ Included		
Nota	ry page (page 6) filled out; Must b	e signed by prope	rtγ owner		✓ Included		
	Class stamped and addressed enve				✓ Included		
	it all documentation, with the exce	ption of the requir	ed addressed	envelopes an	d letters to		
	nadjustments@raleighnc.gov. er the addressed envelopes and lett	ers to					
	opment Services, Development Engi						
	xchange Plaza, Suite 500						
	h NC, 27601	734-7					
For	Office Use Only RI	CEIVED DATE:		DA-			

## Article 8.3, Blocks, Lots, Access Administrative Design Adjustment Findings



The Development Services Director may in accordance with Sec. 10.2.18. approve a design adjustment, subject to all of the following findings. Describe how each item is met:

- A. The requested design adjustment meets the intent of this Article;
  Per Section 8.3.1.C the intent of the Article is to provide safe access through developments. Adding public access for the apartment complex, to the east along a curved section of Little Brier Creek Lane is not providing safe access when there are already two access driveways for the apartments with longer sight distances. Per Section 8.3.1.D there is a 14 foot retaining wall between the end of our driveway and the apartment complex. In addition there is an existing apartment building located directly in-line with our driveway.
- B. The requested design adjustment conforms with the Comprehensive Plan and adopted City plans;

This project has several environmental protection elements and open space conservation preserved areas as stated in the 2030 Comprehensive plan including a large area of preserved wetlands and a protected jurisdictional stream. This design adjustment allows these areas to remain preserved and helps promote sustainable growth patterns and a "greenprint" which is a primary Comprehensive Plan objective. The DA will not affect the Brier Creek Village Plan.

C. The requested design adjustment does not increase congestion or compromise Safety;

This design adjustment will decrease congestion and protect vehicular flow along Little Brier Creek Lane (LBCL). Allowing public road access from our site would allow traffic from the apartment complex, to the east, to enter a travel way at the beginning of a curved section of LBCL which would increase the likely hood of traffic conflicts. The two existing access driveways for the apartments are safer access points to LBCL with larger sight distances.

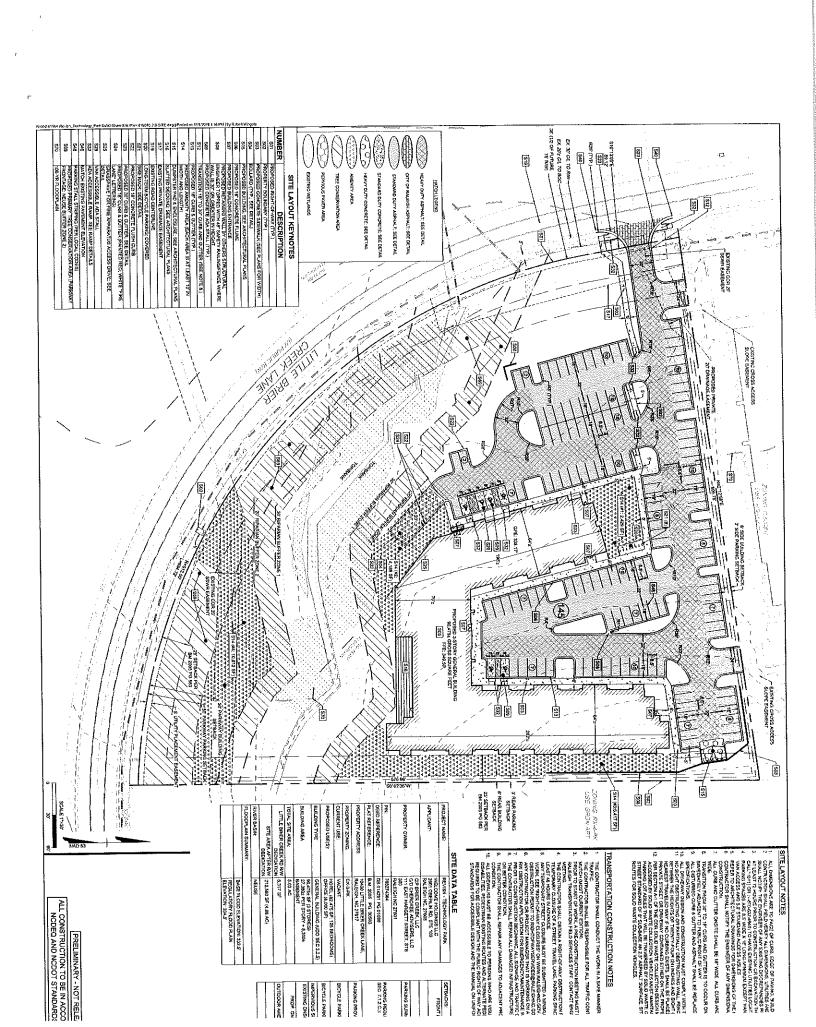
D. The requested design adjustment does not create any lots without direct street Frontage;

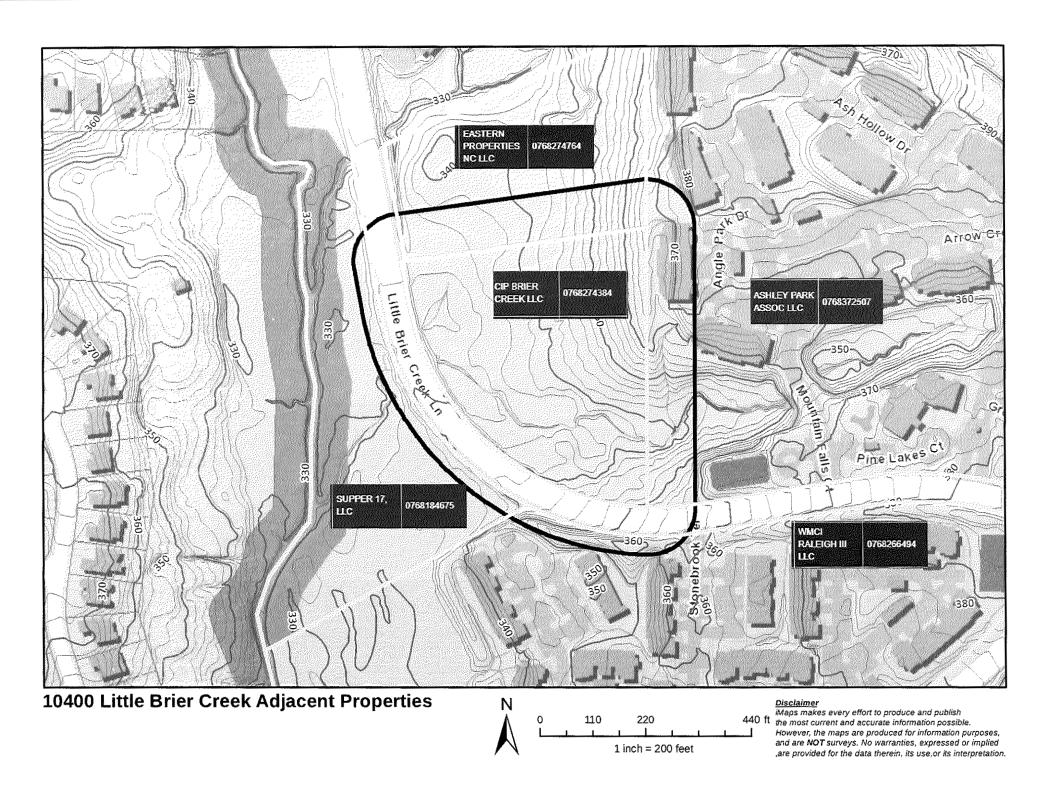
All properties adjacent to the project site already have street frontage on Little Brier Creek Lane.

- E. The requested design adjustment is deemed reasonable due to one or more of the following:
  - 1. Topographic changes are too steep;
  - 2. The presence of existing buildings, stream and other natural features;
  - 3. Site layout of developed properties;
  - 4. Adjoining uses or their vehicles are incompatible;
  - 5. Strict compliance would pose a safety hazard; or
  - 6. Does not conflict with an approved or built roadway construction project
  - 7. adjacent to or in the vicinity of the site.

We believe the design adjustment is reasonable due to the following site constraints:

- 1. There is a proposed 14 foot retaining wall adjacent to the apartments to the east.
- 2. There is an existing apartment building, to the east, located directly in-line with our driveway access. In addition there are extensive wetlands, Parkway TCA and a jurisdictional stream blocking access along the majority of the site frontage along Little Brier Creek Lane.
- 5. Allowing public access to Little Brier Creek Lane would outlet traffic at the beginning of a sharp curve which would increase the likely hood of traffic conflicts with traffic flow. The two existing access driveways from the apartments to the east are safer access points for the apartment traffic on Little Brier Creek Lane.





# **Administrative Site Review Application** (for UDO Districts only) Litchford Satellite Office | 8320 - 130 Litchford Road | Raleigh, NC 27601 | 919-996-4200 When submitting plans, please check the appropriate building type and include the Plan Checklist document Attached ☐ Mixed Use Assigned Project Coordinato Apartment occupancy (per Chapter 6 of the UDO), indicate impacts on parking requirements Project is a hotel with 75 (1 bedroom units) and 25 (2 bedroom units) and 8,000 sf o office space with supporting building services and parking. hone (919) 889-4411 | Email dsw@welcomeholdings.com | Fax N/A

Zoning Information		Building Information	
Zoning District(s) CX-3-PK		Proposed building use(s) Hotel & Office	
f more than one district, provide the acreage of each:		Existing Building(s) sq. ft. gross ()	
Overlay District No		Proposed Building(s) sq. ft. gross 90,475 sf	
Total Site Acres Inside City Limits  Yes No 5.03		Total sq. ft. gross (existing & proposed) 90,475 sf	
Off street parking: Required 145 Provided 145		Proposed height of building(s) 38'	
COA (Certificate of Appropriateness) case #		# of stories Three Stories	
BOA (Board of Adjustment) case # A-		Ceiling height of 1 <sup>st</sup> Floor 11' -4"	
CUD (Conditional Use District) case # Z-			
Stormwate	r Information		
Existing Impervious Surface 0.00 Acres acres/square feet		Flood Hazard Area Yes No	
Proposed Impervious Surface 2.11 Acres acres/square feet		If Yes, please provide:	
Neuse River Buffer 🗏 Yes 🔲 No Wetlands 🗏 Yes 🔲 No	)	Alluvial Soils Flood Study NO FEMA Map Panel # 3720076800J 5/2/2006	
FOR RESIDENTIA	AL DEVELOPI	MENTS	
. Total # Of Apartment, Condominium or Residential Units	5. Bedrooi	m Units: 1br 2br 3br 4br or more	
. Total # Of Congregate Care Or Life Care Dwelling Units	6. Infill De	evelopment 2.2.7	
. Total Number of Hotel Units 100	7. Open Sp	Space (only) or Amenity	
. Overall Total # Of Dwelling Units (1-6 Above) 100	8. Is your p	ur project a cottage court? Yes No	
SIGNATURE BLOCK (Appl	icable to all	developments)	
n filing this plan as the property owner(s), I/we do hereby agree and fir nd assigns jointly and severally to construct all improvements and mak pproved by the City.  Timmons Group	e all dedication	ns as shown on this proposed development plan as	
hereby designateeceive and respond to administrative comments, to resubmit plans on	my behalf and	to serve as my agent regarding this application, to to represent me in any public meeting regarding this	
pplication.	•	, , , , , , , , , , , , , , , , , , , ,	
/we have read, acknowledge and affirm that this project is conforming	to all applicat	on requirements applicable with the proposed developmen	
se.			
igned		Date	
rinted Name			
igned		Date	
rinted Name			

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# ADMINISTRATIVE SITE REVIEW REVISN - TECHNOLOGY PARK

# ASR TRANSACTION #564577 (SR-71-18) 10400 LITTLE BRIER CREEK LANE RALEIGH, NORTH CAROLINA 27617 WAKE COUNTY

## ARCHITECT:

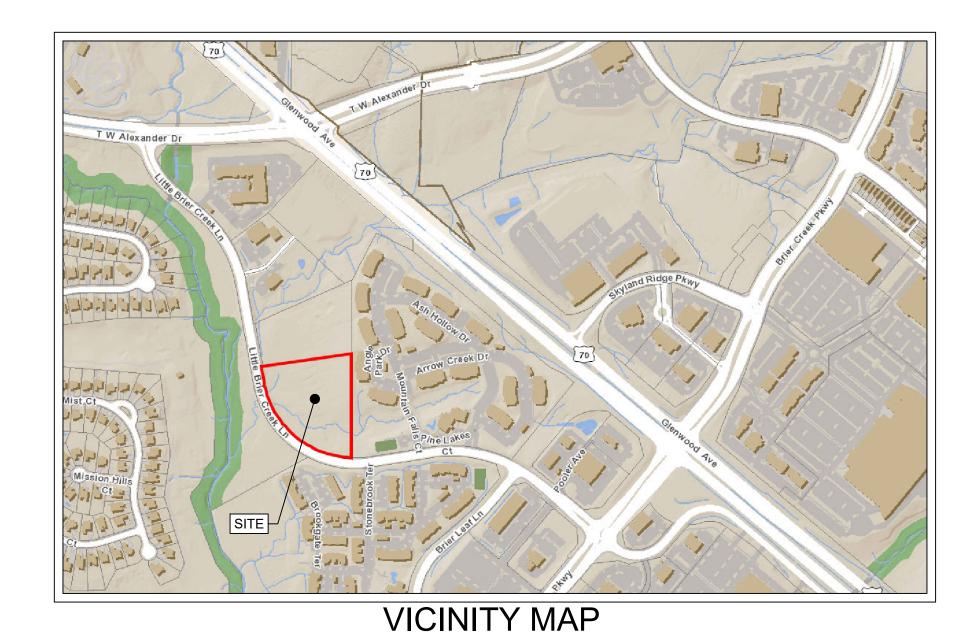
OLIVE ARCHITECTURE F. THOMAS MURPHY, AIA NCARB 436 N. HARRINGTON ST, STE 140 RALEIGH, NC 27603 PH: (919) 838-9934 TOM@OLIVE-ARCH.COM

## **DEVELOPER:**

WELCOME HOLDINGS LLC **DICKY WALIA** 2601 OBERLIN RD, STE 100 RALEIGH NC, 27608 DSW@WELCOMEHOLDINGS.COM

## **CIVIL ENGINEER:**

TIMMONS GROUP PATRICK BARBEAU, P.E. 5410 TRINITY ROAD; SUITE 102 RALEIGH, NC 27607 PH: (919) 866-4512 PATRICK.BARBEAU@TIMMONS.COM



1" = 500'

Sheet Number	Sheet Title
CVR	COVER SHEET
C1.0	EXISTING CONDITIONS
C2.0	SITE PLAN
C2.1	FIRE APPARATUS ACCESS EXHIBIT
C2.2	SOLID WASTE SERVICES ACCESS EXHIBIT
C2.3	SIGHT DISTANCE TRIANGLE PLAN
C3.0	GRADING AND STORM DRAINAGE PLAN
C5.0	UTILITY PLAN
C6.0	LANDSCAPE PLAN
TCA6.1	TREE CONSERVATION PLAN
C7.0	DETAILS
C7.1	DETAILS
C7.2	DETAILS
L100	BASEMENT PLAN AND CALCULATIONS
L104	ROOF PLAN
L200	BUILDING ELEVATIONS
L201	BUILDING ELEVATIONS
L202	BUILDING ELEVATIONS
L300	TRANSPARENCY CALCULATIONS
L301	TRANSPARENCY CALCULATIONS
L302	TRANSPARENCY CALCULATIONS
L303	TRANSPARENCY CALCULATIONS
L1.0	LIGHTING PLAN
	·

**Sheet List Table** 

PUBLIC IMPROVED  QUANTITY TAB	
PHASE NUMBER(S)	PHASE 1
NUMBER OF LOT(S)	1
LOT NUMBER(S) BY PHASE	N/A
NUMBER OF UNITS	1
LIVABLE BUILDINGS	1
OPEN SPACE	N/A
NUMBER OF OPEN SPACE LOTS	0
PUBLIC WATER (LF)	0
PUBLIC SEWER (LF)	0
PUBLIC STREET (LF) - FULL	0
PUBLIC STREET (LF) - PARTIAL	0
PUBLIC SIDEWALK (LF)	0
STREET SIGNS (LF)	0
WATER SERVICE STUBS	1
SEWER SERVICE STUBS	1

BUBLIA IMBBAVEMENT

**REVISION 05.13.16** 

- SITE IS EXEMPT FROM ACTIVE STORMWATER CONTROLS PER CITY OF RALEIGH UDO 9.2.2.E.2.d. 2. SITE DOES NOT EXCEED 10 LBS/AC/YR IN NITROGEN EXPORT LOADING. PER CITY OF RALEIGH UDO 9.2.2.B.2., STORMWATER NITROGEN EXPORT LOADING SHALL BE OFF-SET THROUGH A
- 3. SOLID WASTE MANAGEMENT WILL BE MANAGED THROUGH PRIVATE CONTRACTOR AND ON-SITE
- 4. PROJECT SHALL COMPLY WITH CITY OF RALEIGH TREE CONSERVATION REQUIREMENTS

PRELIMINARY - NOT RELEASED FOR CONSTRUCTION

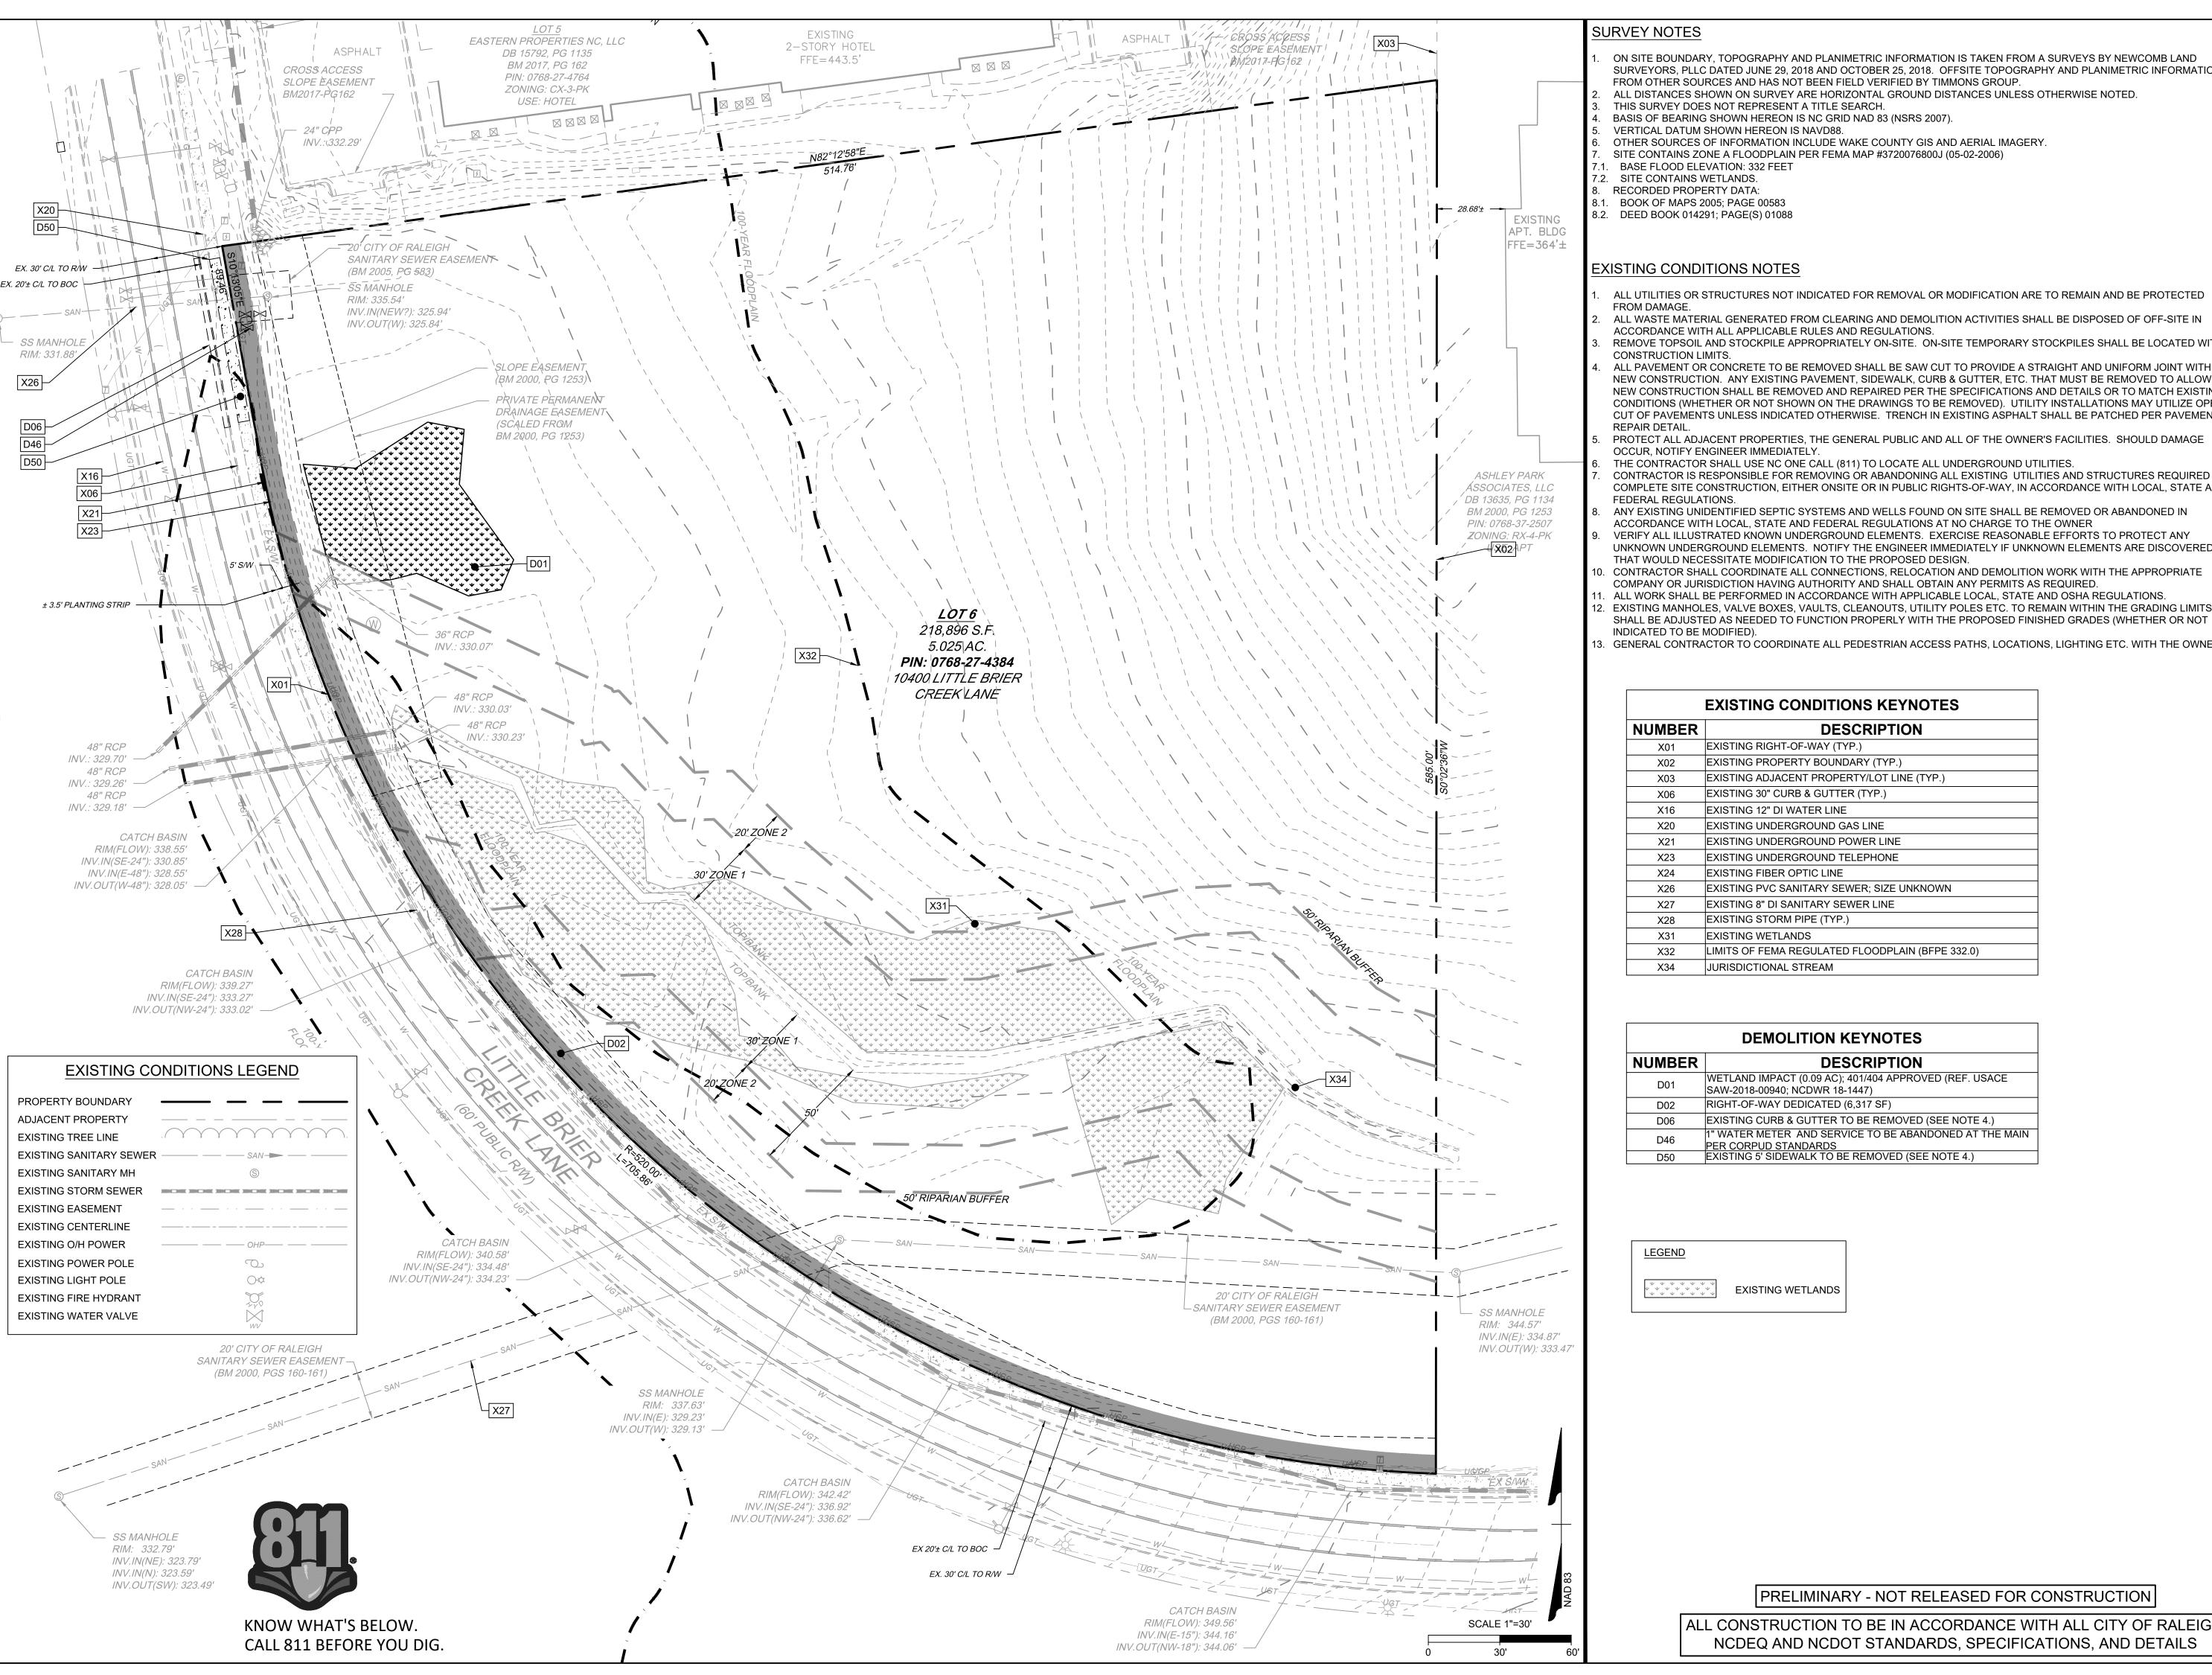
ALL CONSTRUCTION TO BE IN ACCORDANCE WITH ALL CITY OF RALEIGH, NCDEQ AND NCDOT STANDARDS, SPECIFICATIONS, AND DETAILS

07/31/2018 DRAWN BY R. WINGATE R. WINGATE CHECKED BY P. BARBEAL **AS SHOWN** 

SHEET NO.

PAGE 2 OF 3

KNOW WHAT'S BELOW. CALL 811 BEFORE YOU DIG.



## **SURVEY NOTES**

- ON SITE BOUNDARY, TOPOGRAPHY AND PLANIMETRIC INFORMATION IS TAKEN FROM A SURVEYS BY NEWCOMB LAND SURVEYORS, PLLC DATED JUNE 29, 2018 AND OCTOBER 25, 2018. OFFSITE TOPOGRAPHY AND PLANIMETRIC INFORMATION FROM OTHER SOURCES AND HAS NOT BEEN FIELD VERIFIED BY TIMMONS GROUP.
- ALL DISTANCES SHOWN ON SURVEY ARE HORIZONTAL GROUND DISTANCES UNLESS OTHERWISE NOTED.
- THIS SURVEY DOES NOT REPRESENT A TITLE SEARCH.
- BASIS OF BEARING SHOWN HEREON IS NC GRID NAD 83 (NSRS 2007).
- VERTICAL DATUM SHOWN HEREON IS NAVD88. OTHER SOURCES OF INFORMATION INCLUDE WAKE COUNTY GIS AND AERIAL IMAGERY.
- SITE CONTAINS ZONE A FLOODPLAIN PER FEMA MAP #3720076800J (05-02-2006)
- BASE FLOOD ELEVATION: 332 FEET
- 7.2. SITE CONTAINS WETLANDS.
- RECORDED PROPERTY DATA:
- 8.1. BOOK OF MAPS 2005; PAGE 00583

## **EXISTING CONDITIONS NOTES**

- ALL UTILITIES OR STRUCTURES NOT INDICATED FOR REMOVAL OR MODIFICATION ARE TO REMAIN AND BE PROTECTED
- ALL WASTE MATERIAL GENERATED FROM CLEARING AND DEMOLITION ACTIVITIES SHALL BE DISPOSED OF OFF-SITE IN
- ACCORDANCE WITH ALL APPLICABLE RULES AND REGULATIONS. REMOVE TOPSOIL AND STOCKPILE APPROPRIATELY ON-SITE. ON-SITE TEMPORARY STOCKPILES SHALL BE LOCATED WITHIN
- ALL PAVEMENT OR CONCRETE TO BE REMOVED SHALL BE SAW CUT TO PROVIDE A STRAIGHT AND UNIFORM JOINT WITH NEW CONSTRUCTION. ANY EXISTING PAVEMENT, SIDEWALK, CURB & GUTTER, ETC. THAT MUST BE REMOVED TO ALLOW NEW CONSTRUCTION SHALL BE REMOVED AND REPAIRED PER THE SPECIFICATIONS AND DETAILS OR TO MATCH EXISTING CONDITIONS (WHETHER OR NOT SHOWN ON THE DRAWINGS TO BE REMOVED). UTILITY INSTALLATIONS MAY UTILIZE OPEN CUT OF PAVEMENTS UNLESS INDICATED OTHERWISE. TRENCH IN EXISTING ASPHALT SHALL BE PATCHED PER PAVEMENT REPAIR DETAIL.
- PROTECT ALL ADJACENT PROPERTIES, THE GENERAL PUBLIC AND ALL OF THE OWNER'S FACILITIES. SHOULD DAMAGE OCCUR. NOTIFY ENGINEER IMMEDIATELY.
- THE CONTRACTOR SHALL USE NC ONE CALL (811) TO LOCATE ALL UNDERGROUND UTILITIES.
- CONTRACTOR IS RESPONSIBLE FOR REMOVING OR ABANDONING ALL EXISTING UTILITIES AND STRUCTURES REQUIRED TO COMPLETE SITE CONSTRUCTION, EITHER ONSITE OR IN PUBLIC RIGHTS-OF-WAY, IN ACCORDANCE WITH LOCAL, STATE AND
- ANY EXISTING UNIDENTIFIED SEPTIC SYSTEMS AND WELLS FOUND ON SITE SHALL BE REMOVED OR ABANDONED IN ACCORDANCE WITH LOCAL. STATE AND FEDERAL REGULATIONS AT NO CHARGE TO THE OWNER
- VERIFY ALL ILLUSTRATED KNOWN UNDERGROUND ELEMENTS. EXERCISE REASONABLE EFFORTS TO PROTECT ANY UNKNOWN UNDERGROUND ELEMENTS. NOTIFY THE ENGINEER IMMEDIATELY IF UNKNOWN ELEMENTS ARE DISCOVERED THAT WOULD NECESSITATE MODIFICATION TO THE PROPOSED DESIGN.
- CONTRACTOR SHALL COORDINATE ALL CONNECTIONS, RELOCATION AND DEMOLITION WORK WITH THE APPROPRIATE
- COMPANY OR JURISDICTION HAVING AUTHORITY AND SHALL OBTAIN ANY PERMITS AS REQUIRED.
- ALL WORK SHALL BE PERFORMED IN ACCORDANCE WITH APPLICABLE LOCAL, STATE AND OSHA REGULATIONS. EXISTING MANHOLES, VALVE BOXES, VAULTS, CLEANOUTS, UTILITY POLES ETC. TO REMAIN WITHIN THE GRADING LIMITS
- INDICATED TO BE MODIFIED). 3. GENERAL CONTRACTOR TO COORDINATE ALL PEDESTRIAN ACCESS PATHS, LOCATIONS, LIGHTING ETC. WITH THE OWNER.

EXISTING CONDITIONS KEYNOTES				
NUMBER	DESCRIPTION			
X01	EXISTING RIGHT-OF-WAY (TYP.)			
X02	EXISTING PROPERTY BOUNDARY (TYP.)			
X03	EXISTING ADJACENT PROPERTY/LOT LINE (TYP.)			
X06	EXISTING 30" CURB & GUTTER (TYP.)			
X16	EXISTING 12" DI WATER LINE			
X20	EXISTING UNDERGROUND GAS LINE			
X21	EXISTING UNDERGROUND POWER LINE			
X23	EXISTING UNDERGROUND TELEPHONE			
X24	EXISTING FIBER OPTIC LINE			
X26	EXISTING PVC SANITARY SEWER; SIZE UNKNOWN			
X27	EXISTING 8" DI SANITARY SEWER LINE			
X28	EXISTING STORM PIPE (TYP.)			
X31	EXISTING WETLANDS			
X32	LIMITS OF FEMA REGULATED FLOODPLAIN (BFPE 332.0)			
X34	JURISDICTIONAL STREAM			

DEMOLITION KEYNOTES				
NUMBER	DESCRIPTION			
D01	WETLAND IMPACT (0.09 AC); 401/404 APPROVED (REF. USACE SAW-2018-00940; NCDWR 18-1447)			
D02 RIGHT-OF-WAY DEDICATED (6,317 SF)				
D06	EXISTING CURB & GUTTER TO BE REMOVED (SEE NOTE 4.)			
D46	1" WATER METER AND SERVICE TO BE ABANDONED AT THE MAIN PER CORPUD STANDARDS			
D50 EXISTING 5' SIDEWALK TO BE REMOVED (SEE NOTE 4.)				

<u>LEGEND</u> **EXISTING WETLANDS** 

PRELIMINARY - NOT RELEASED FOR CONSTRUCTION

ALL CONSTRUCTION TO BE IN ACCORDANCE WITH ALL CITY OF RALEIGH, NCDEQ AND NCDOT STANDARDS, SPECIFICATIONS, AND DETAILS

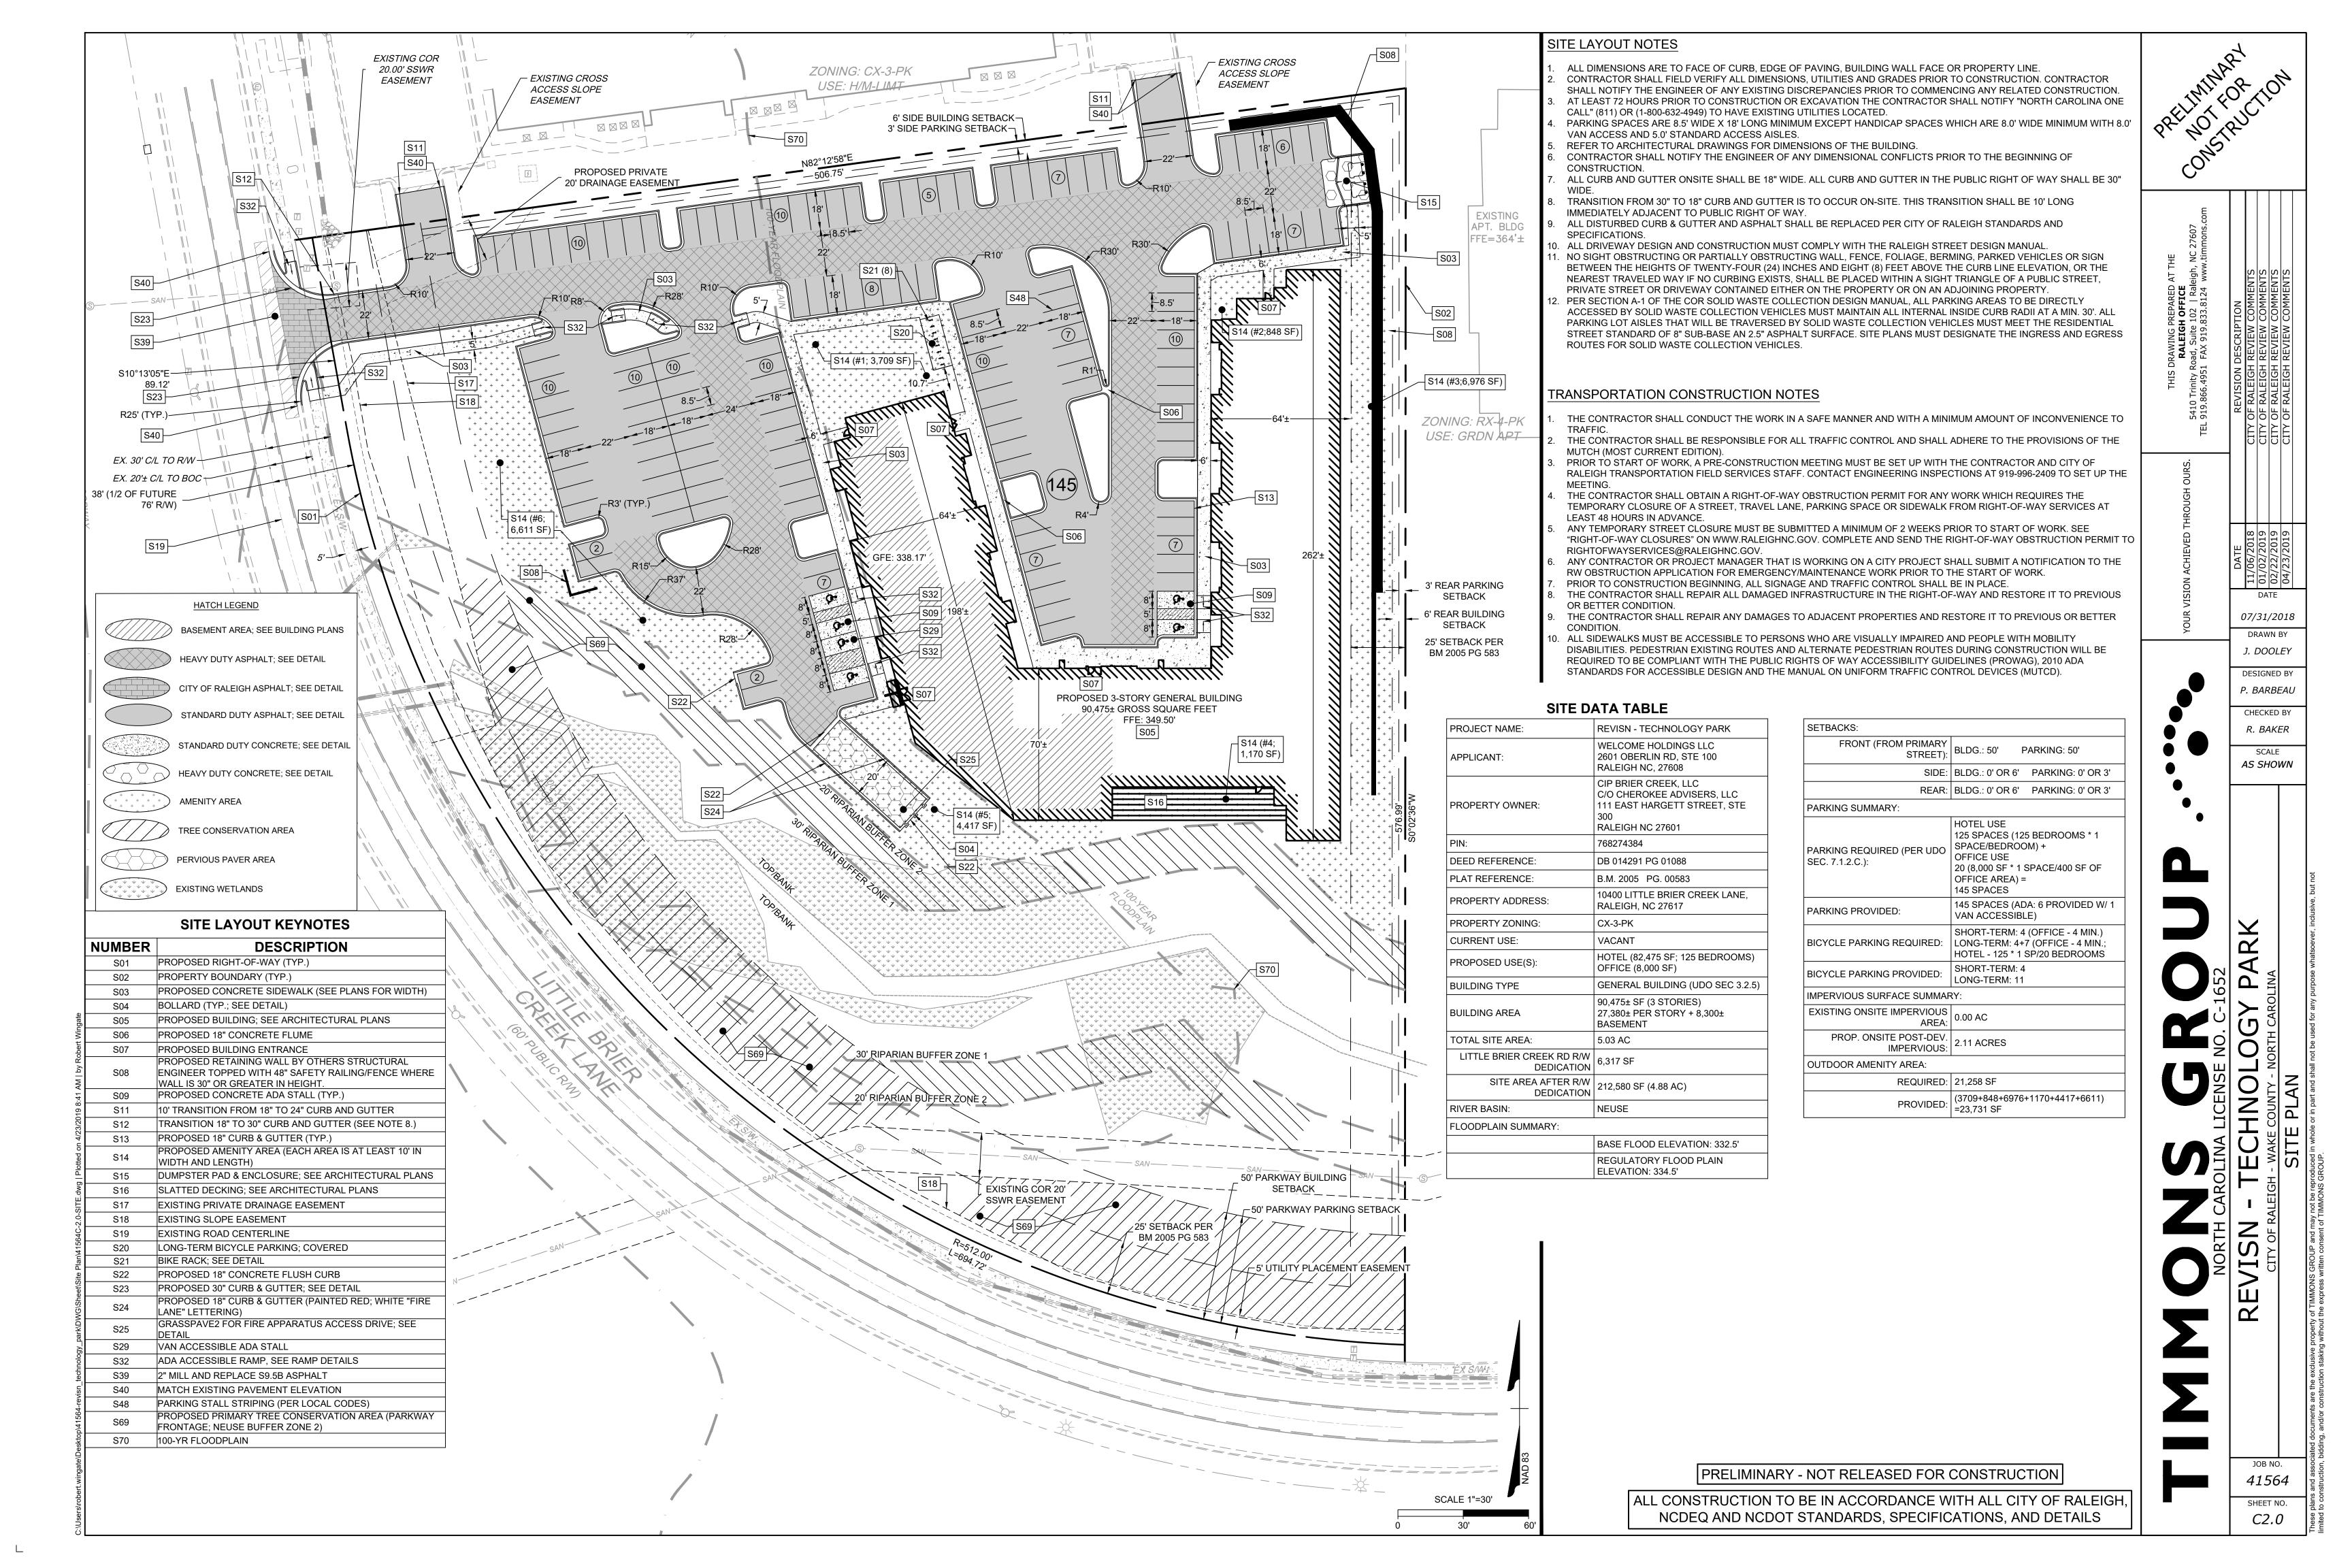
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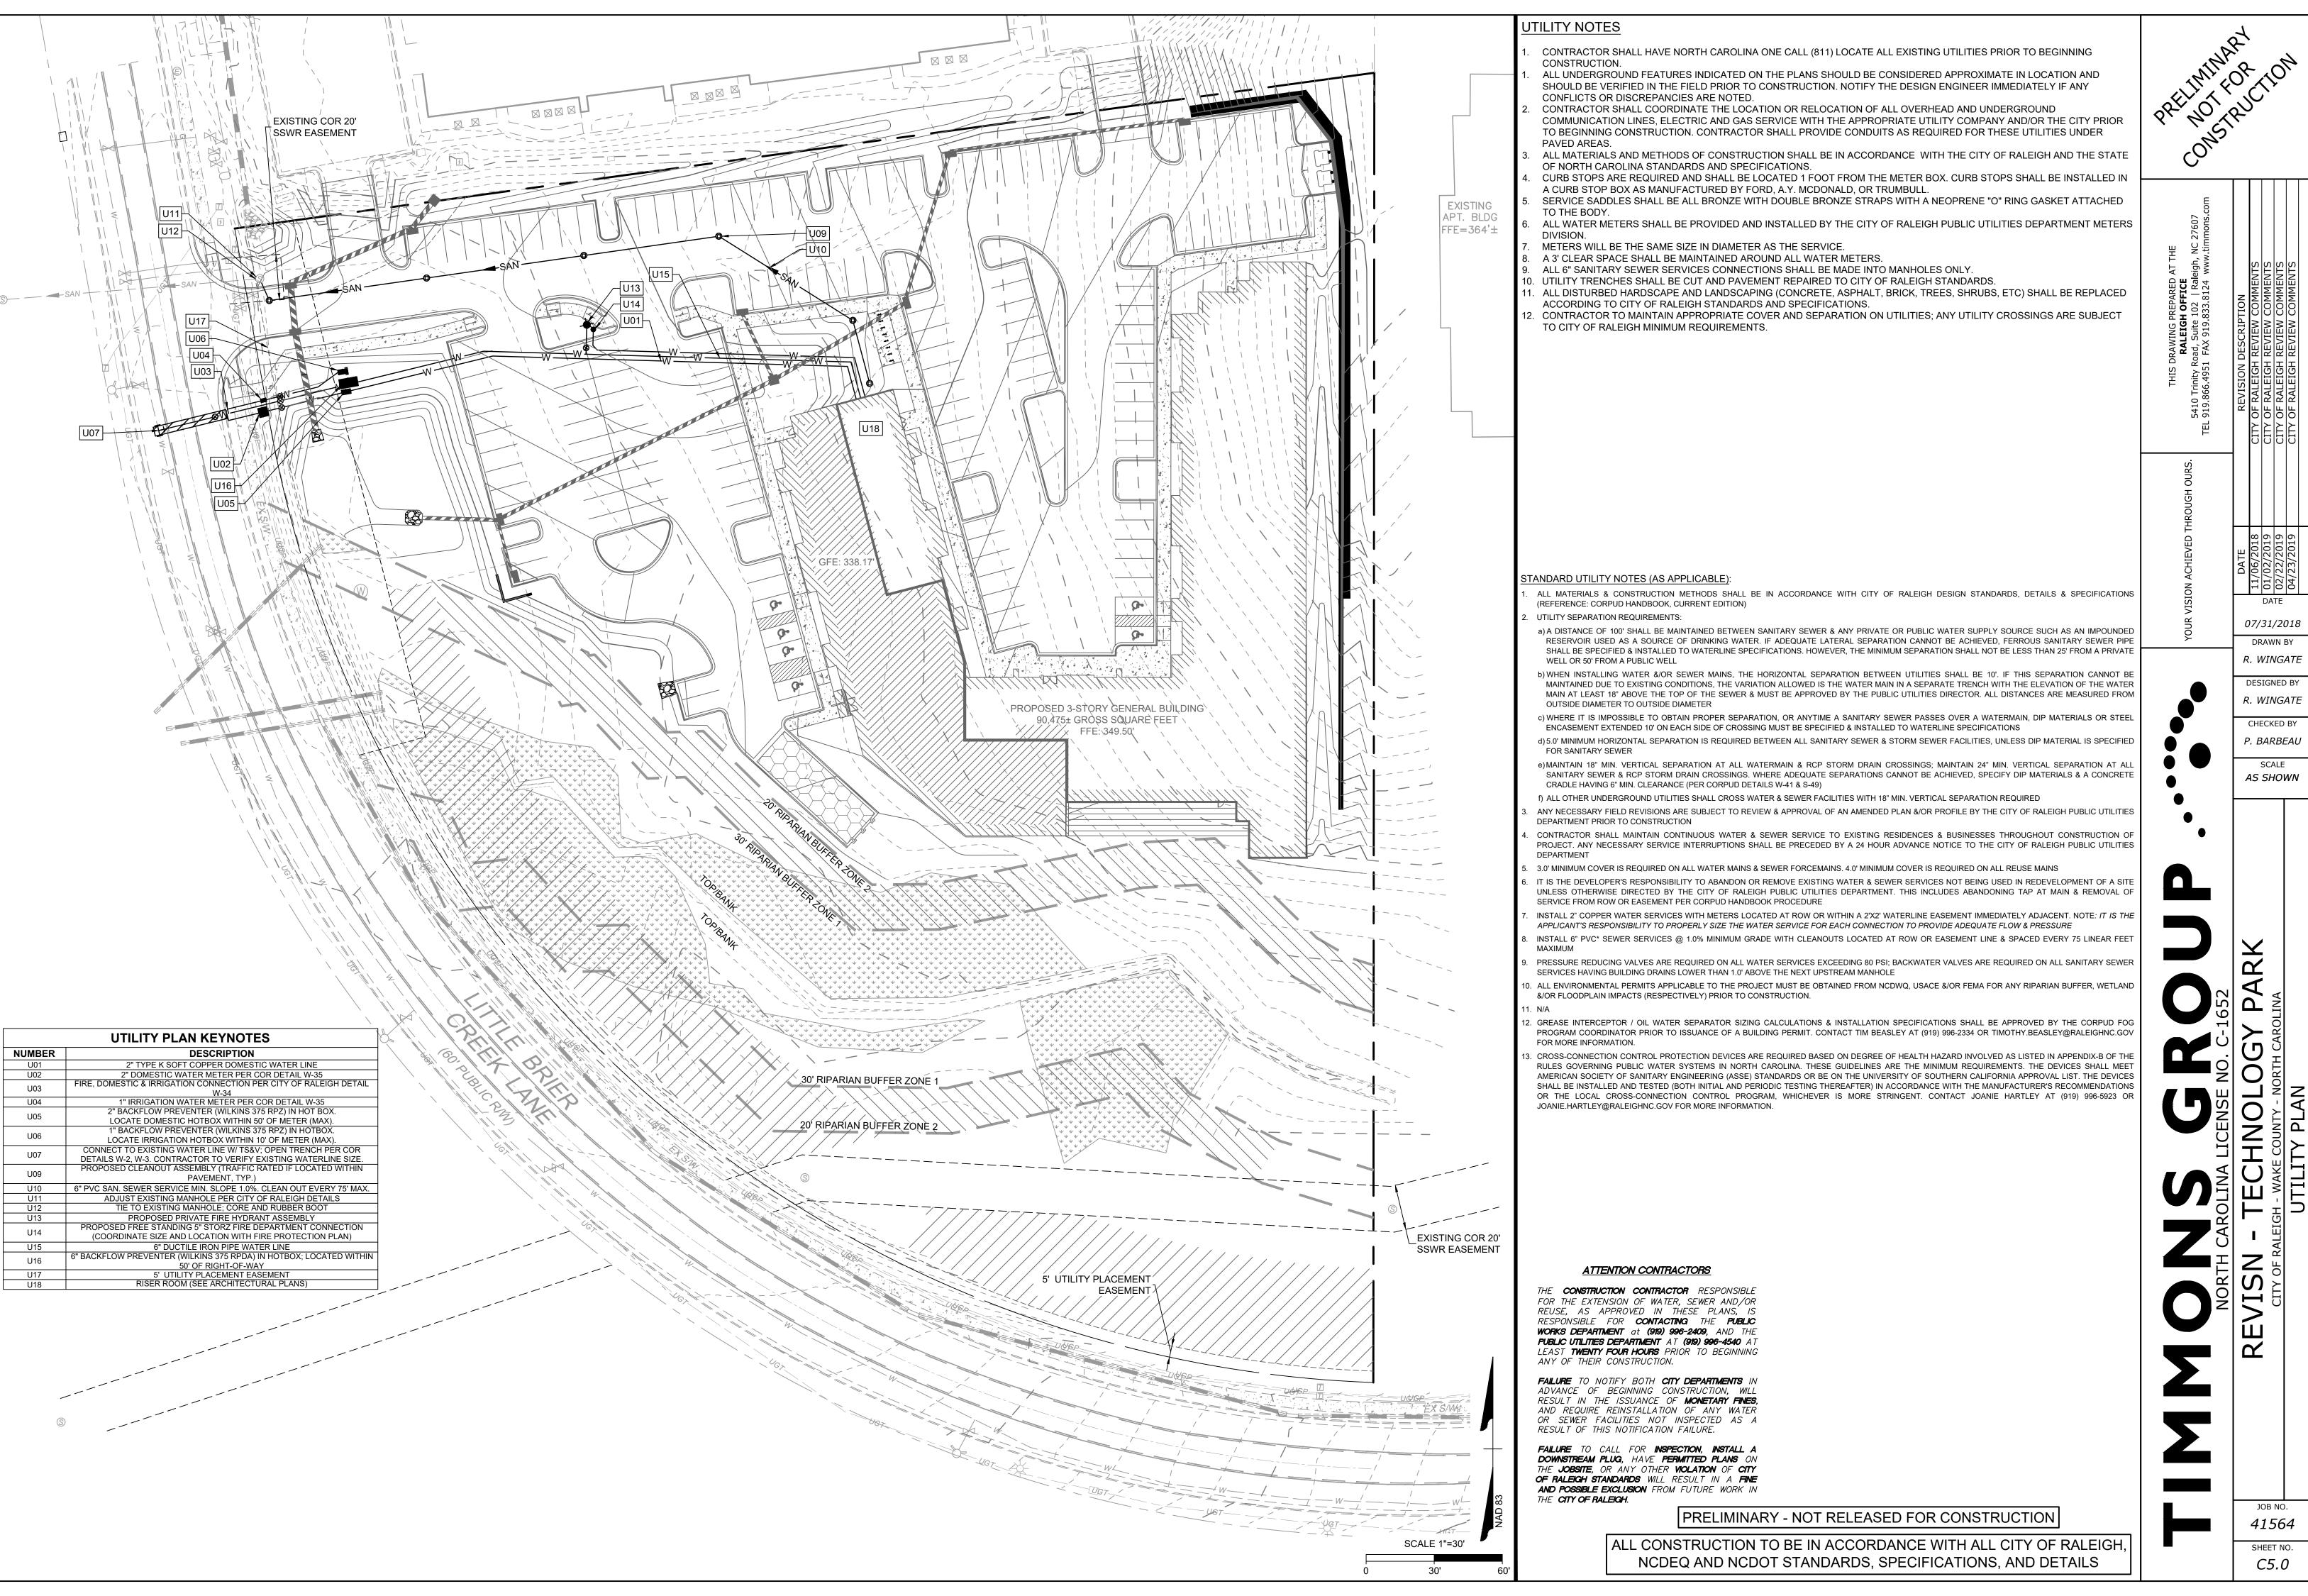
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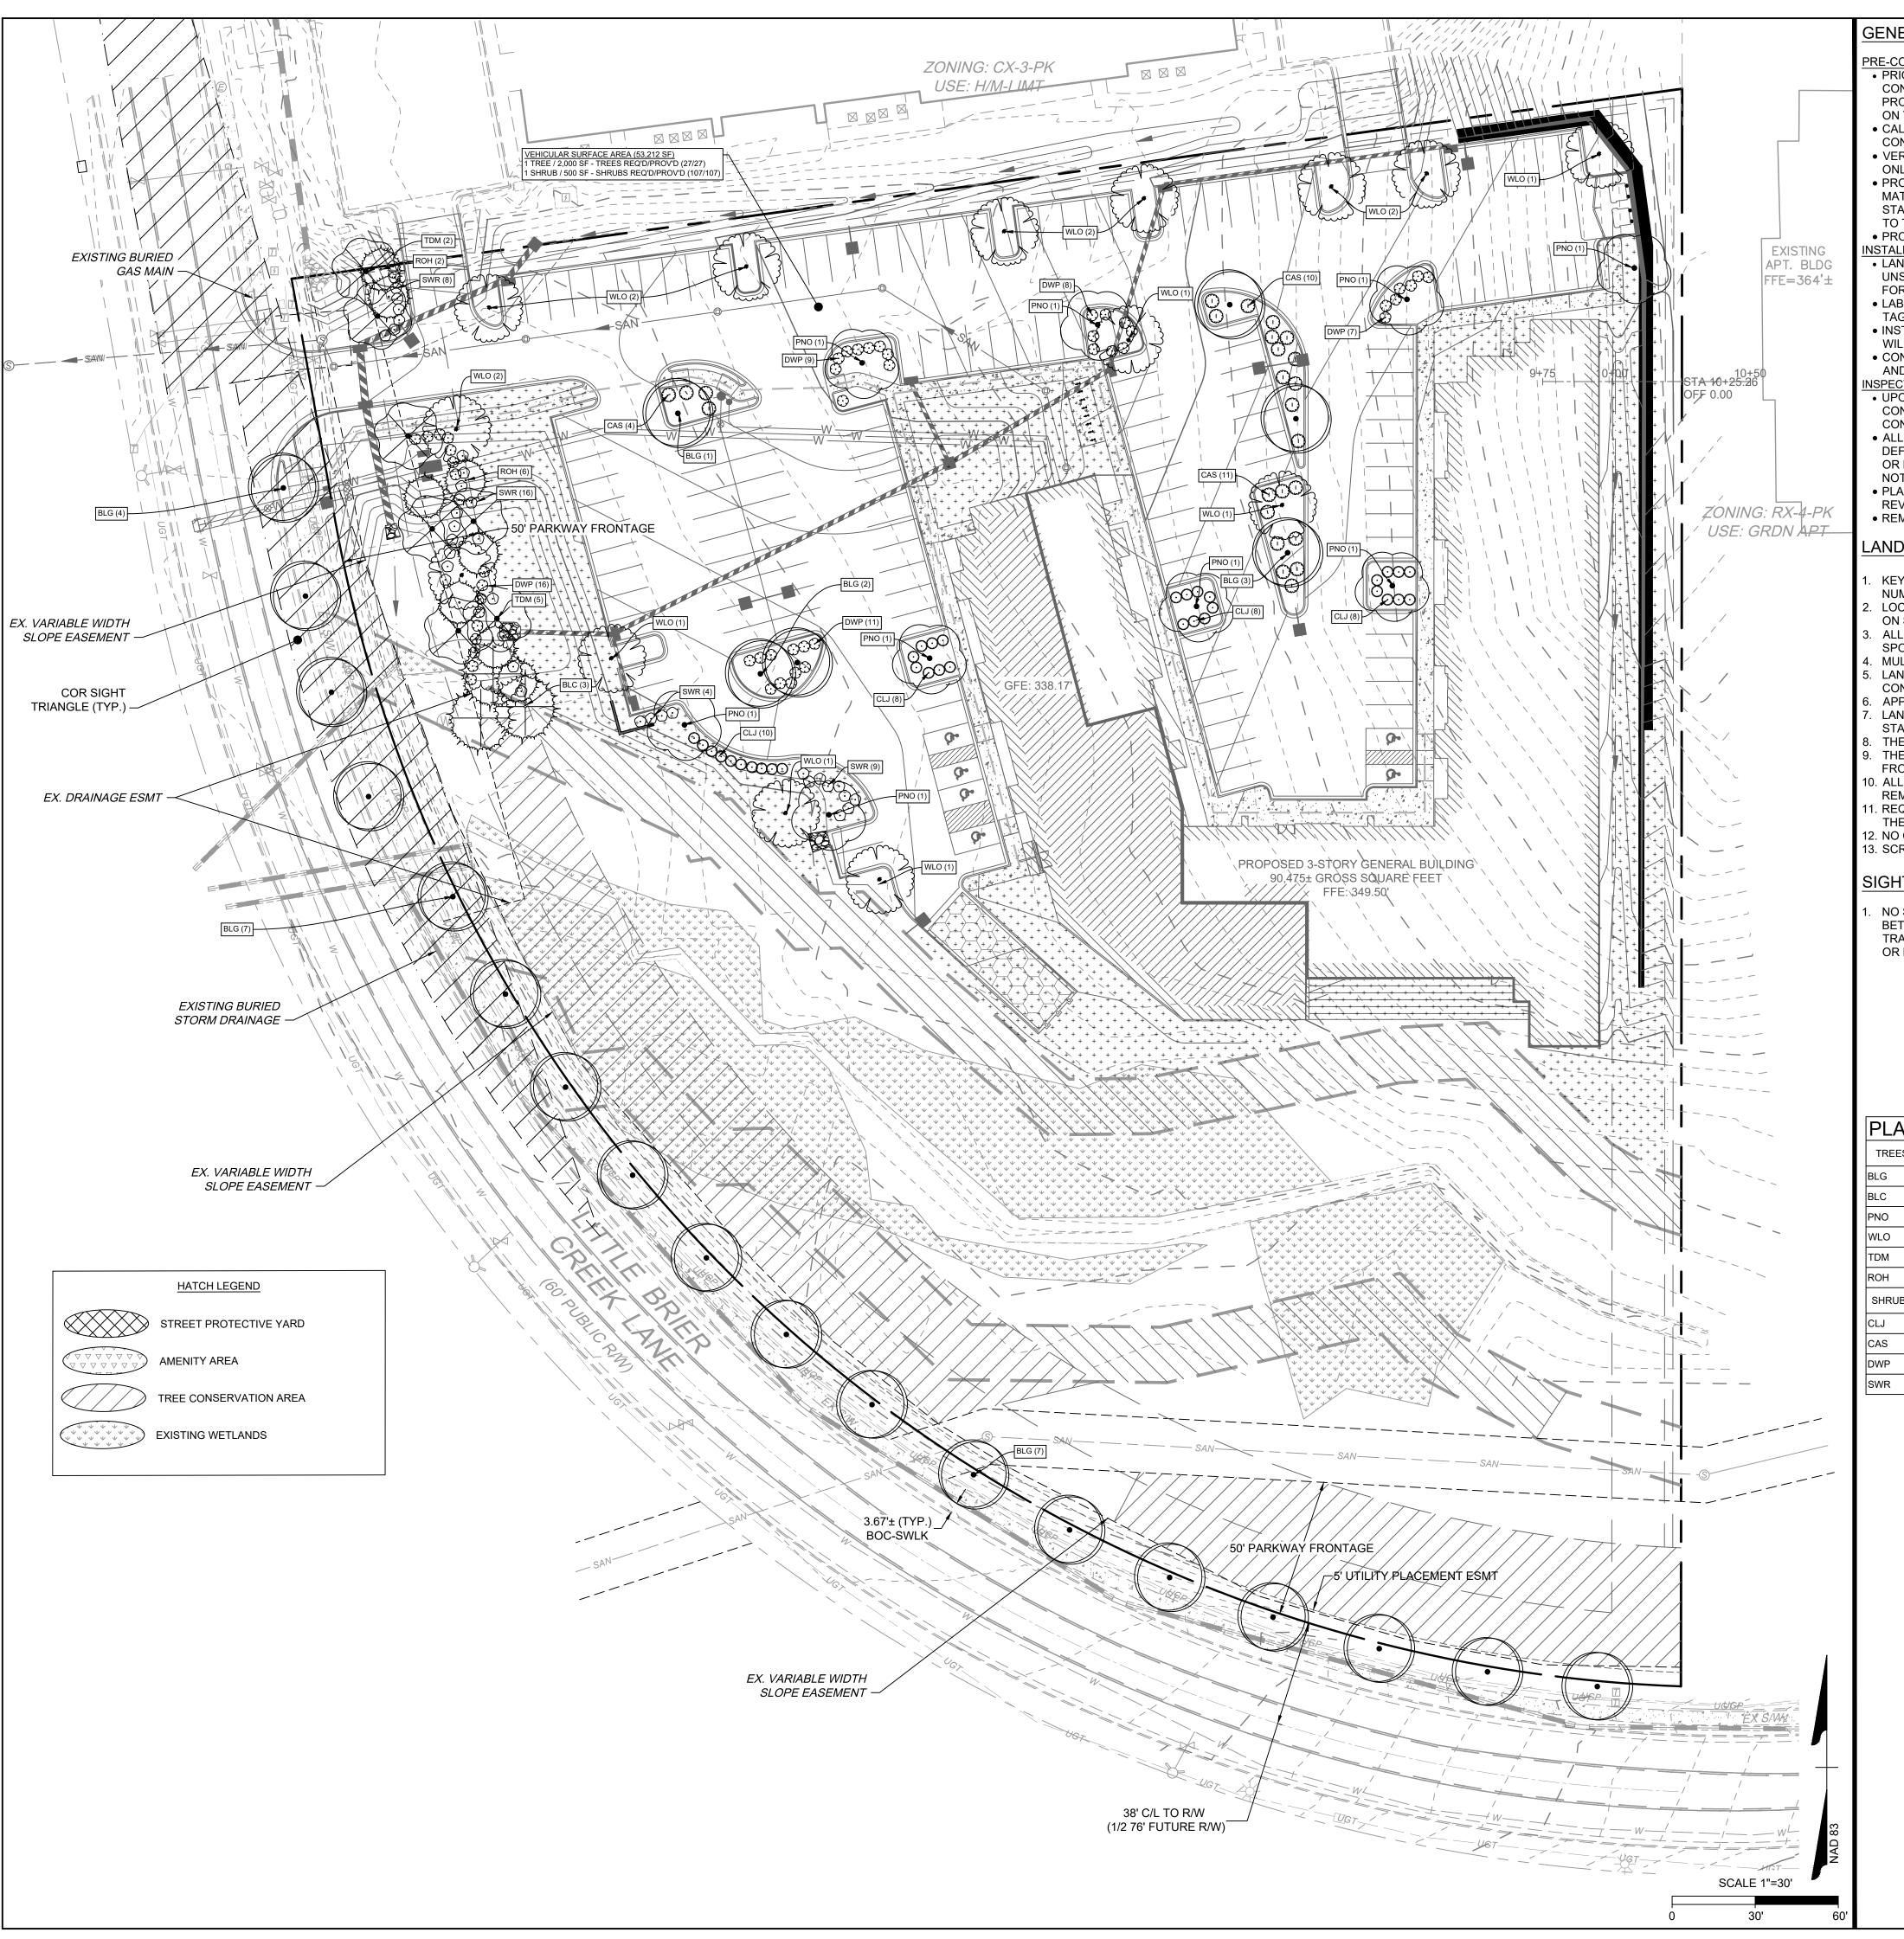
R. WINGATE CHECKED BY P. BARBEAU

**AS SHOWN** 

SHEET NO.







## GENERAL NOTES

- PRIOR TO THE COMMENCEMENT OF ANY ACTIVITIES REQUIRING A BUILDING OR ZONING PERMIT AN ON-SITE PRE CONSTRUCTION CONFERENCE SHALL TAKE PLACE WITH THE DEVELOPER AND THE ADMINISTRATOR TO REVIEW PROCEDURES FOR THE PROTECTION AND MANAGEMENT OF ALL LANDSCAPE ELEMENTS THAT ARE TO REMAIN AS IDENTIFIED
- ON THE LANDSCAPE PLAN. • CALL 811 FOR LOCATION OF ALL UTILITY LINES. TREES SHALL BE LOCATED A MINIMUM OF 5 FEET FROM SEWER/WATER
- CONNECTIONS AND BURIED UTILITIES. NOTIFY LANDSCAPE ARCHITECT OF CONFLICTS. • VERIFY ALL PLANT MATERIAL QUANTITIES ON THE PLAN PRIOR TO BIDDING, PLANT LIST TOTALS ARE FOR CONVENIENCE
- ONLY AND SHALL BE VERIFIED PRIOR TO BIDDING. • PROVIDE PLANT MATERIALS OF QUANTITY, SIZE, GENUS, SPECIES, AND VARIETY INDICATED ON PLANS. ALL PLANT
- MATERIALS AND INSTALLATION SHALL COMPLY WITH RECOMMENDATIONS AND REQUIREMENTS OF ANSI Z60.1 "AMERICAN STANDARD FOR NURSERY STOCK". IF SPECIFIED PLANT MATERIAL IS NOT OBTAINABLE, SUBMIT PROOF OF NON AVAILABILITY TO THE ARCHITECTS, TOGETHER WITH PROPOSAL FOR USE OF EQUIVALENT MATERIAL.
- PROVIDE AND INSTALL ALL PLANTS AS IN ACCORDANCE WITH DETAILS AND CONTRACT SPECIFICATIONS.
- LANDSCAPE ARCHITECT RESERVES THE RIGHT TO REJECT ANY PLANTS AND MATERIALS THAT ARE IN AN UNHEALTHY OR UNSIGHTLY CONDITION, AS WELL AS PLANTS AND MATERIALS THAT DO NOT CONFORM TO ANSI Z60.1 "AMERICAN STANDARD FOR NURSERY STOCK".
- LABEL AT LEAST ONE TREE AND ONE SHRUB OF EACH VARIETY AND CALIPER WITH A SECURELY ATTACHED, WATERPROOF TAG BEARING THE DESIGNATION OF BOTANICAL AND COMMON NAME.
- INSTALL LANDSCAPE PLANTINGS AT ENTRANCES/EXITS AND PARKING AREAS ACCORDING TO PLANS SO THAT MATERIALS WILL NOT INTERFERE WITH SIGHT DISTANCES.
- CONTRACTOR IS RESPONSIBLE FOR WATERING ALL PLANT MATERIAL DURING INSTALLATION AND UNTIL FINAL INSPECTION AND ACCEPTANCE BY OWNER. CONTRACTOR SHALL NOTIFY OWNER OF CONDITIONS WHICH AFFECTS THE GUARANTEE.
- UPON COMPLETION OF LANDSCAPE INSTALLATION, THE LANDSCAPE CONTRACTOR SHALL NOTIFY THE GENERAL
- CONTRACTOR WHO WILL VERIFY COMPLETENESS, INCLUDING THE REPLACEMENT OF ALL DEAD PLANT MATERIAL.
- CONTRACTOR IS RESPONSIBLE FOR SCHEDULING A FINAL INSPECTION BY THE LANDSCAPE ARCHITECT.
- ullet ALL EXTERIOR PLANT MATERIALS SHALL BE GUARANTEED FOR ONE FULL YEAR AFTER DATE OF FINAL INSPECTION AGAINST DEFECTS INCLUDING DEATH AND UNSATISFACTORY GROWTH. DEFECTS RESULTING FROM NEGLECT BY THE OWNER, ABUSE OR DAMAGE BY OTHERS, OR UNUSUAL PHENOMENA OR INCIDENTS WHICH ARE BEYOND THE CONTRACTORS CONTROL ARE
- NOT THE RESPONSIBILITY OF THE CONTRACTOR. • PLANT MATERIAL QUANTITIES AND SIZES WILL BE INSPECTED FOR COMPLIANCE WITH APPROVED PLANS BY A SITE PLAN
- REVIEW AGENT OF THE PLANNING DEPARTMENT PRIOR TO THE RELEASE OF THE CERTIFICATE OF OCCUPANCY. • REMOVE ALL GUY WIRES AND STAKES 12 MONTHS AFTER INSTALLATION.

## LANDSCAPE NOTES

- KEY REFERS TO PLANT LIST. WHERE THERE IS ONLY A KEY, THE QUANTITY IS ONE. WHERE THE KEY IS FOLLOWED BY A NUMBER, THE NUMBER IS THE QUANTITY REQUIRED FOR THE INDICATED PLANT BED.
- LOCATE PLANTS AND PLANTING BEDS BY USING SCALED DIMENSIONS FROM STREET, PROPERTY LINES, ETC. DIMENSIONS
- ON STREET YARDS, BUFFERS AND LANDSCAPE AREAS ARE A MINIMUM WIDTH AND SHALL NOT BE REDUCED. ALL PLANTS SHALL MEET OR EXCEED THE MINIMUM STANDARDS SET BY THE U.S.D.A. STANDARD FOR NURSERY STOCK SPONSORED BY THE AMERICAN ASSOCIATION OF NURSERYMEN, INC., WASHINGTON, D.C.
- MULCH ALL TREES AND PLANTING BEDS AS NOTED ON DRAWING. ALL PLANT GROUPINGS ARE CONSIDERED PLANTING BEDS. LANDSCAPE CONTRACTOR SHALL VERIFY UTILITY AND STORM DRAINAGE LOCATIONS IN THE FIELD PRIOR TO BEGINNING
- CONSTRUCTION. ANY CONFLICTS WITH UTILITIES SHALL BE MOVED.
- APPLY PRE-EMERGENT HERBICIDE TO ALL PLANTING BEDS PER MANUFACTURER'S SPECIFICATIONS. LANDSCAPE CONTRACTOR SHALL SEED AREAS DESIGNATED ON PLAN WITH STATESMAN BLEND FESCUE BY SOUTHERN
- STATES SEED, OR APPROVED EQUAL. THE SITE SHALL BE STABILIZED AND SEEDED PRIOR TO THE ISSUANCE OF A CERTIFICATE OF OCCUPANCY.
- THE SIZE OF THE PLANTING AREA AND SIZE OF PLANT MATERIAL AT MATURITY SHALL ALLOW FOR A 2.5' BUMPER OVERHANG
- 0. ALL TREE PROTECTION FENCING SHALL BE MAINTAINED UNTIL ALL SITE WORK IS COMPLETED. THE FENCING SHALL BE REMOVED PRIOR TO THE FINAL SITE INSPECTION FOR THE CERTIFICATE OF OCCUPANCY (CO).
- 1. REQUIRED STREET TREES THAT ARE LOCATED WITHIN A SIGHT DISTANCE TRIANGLE SHALL BE LIMBED UP TO 8' TO PREVENT THE OBSTRUCTION OF VISION.
- 12. NO CANOPY TYPE TREES ARE TO BE PLACED IN PUBLIC UTILITY EASEMENTS.
- 13. SCREEN WALLS ARE NON-STRUCTURAL WALLS THAT PROVIDE A VISUAL BARRIER BETWEEN ADJACENT PROPERTIES.

## SIGHT DISTANCE:

NO SIGHT OBSTRUCTING OR PARTIALLY OBSTRUCTING WALL, FENCE FOLIAGE, BERMING, PARKED VEHICLES OR SIGN BETWEEN THE HEIGHTS OF TWENTY-FOUR INCHES AND EIGHT FEET ABOVE THE CURB LINE ELEVATION, OR THE NEAREST TRAVELED WAY IF NO CURBING EXISTS, SHALL BE PLACED WITHIN A SIGHT TRIANGLE OF A PUBLIC STREET, PRIVATE STREET OR DRIVEWAY CONTAINED EITHER ON THE PROPERTY OR ON AN ADJOINING PROPERTY.

## PLANT\_SCHEDULE

TREES	QTY	BOTANICAL NAME	COMMON NAME	MINIMUM INSTALLED SIZE	ROOT	REMARKS
BLG	24	NYSSA SYLVATICA	BLACK GUM	3" CALIPER & 10' HT.	B&B	VSA/STREET TREE
BLC	3	TAXODIUM DISTICHUM	BALD CYPRESS	3.5" CALIPER & 14' HT.	B&B	PROT. YARD
PNO	9	QUERCUS PALUSTRIS	PIN OAK	3" CALIPER & 10' HT.	B&B	VSA/BUFFER
WLO	14	QUERCUS PHELLOS	WILLOW OAK	3.5" CALIPER	B&B	VSA/BUFFER
TDM	7	ACER BUERGERIANUM	TRIDENT MAPLE	3" MIN. CALIPER & 10' HT.	B&B	PROT. YARD
ROH	8	ILEX "CONIN"	ROBIN HOLLY	1.5" MIN. CALIPER & 6' HT.	B&B	PROT. YARD
SHRUBS	QTY	BOTANICAL NAME	COMMON NAME	MINIMUM INSTALLED SIZE	ROOT	SPACING
CLJ	34	CLEYERA JAPONICA	JAPANESE CLYERA	18" HT.	CONTAINER	4` OC
CAS	25	CAMELLIA SASANQUA	SASANQUA CAMELLIA	36" HT.	CONTAINER	5` OC
DWP	51	PITTOSPORUM TOBIRA `WHEELER`S DWARF`	DWARF PITTOSPORUM	18" HT.	CONTAINER	4` OC
SWR	37	RHAPHIOLEPIS UMBELLATA `SNOW WHITE`	SNOW WHITE RHAPHIOLEPIS	18" HT.	CONTAINER	4` OC

07/31/2018

DRAWN BY R. WINGATE

**DESIGNED BY** P. BARBEAU

CHECKED BY P. BARBEAU

AS SHOWN

SHEET NO. C6.0

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BUILDING ELEVATIONS

ARCHITECTURE

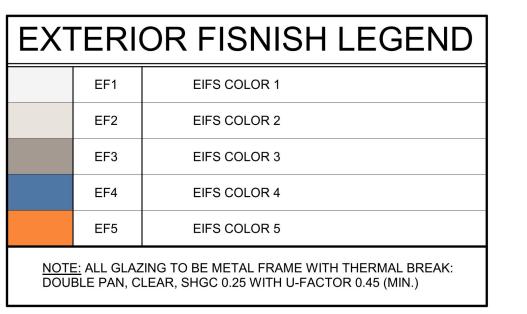
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EF1	OR FISNISH LEGEND
EF2	EIFS COLOR 2
EF3	EIFS COLOR 3
EF4	EIFS COLOR 4
EF5	EIFS COLOR 5
 	ING TO BE METAL FRAME WITH THERMAL BREAK: LEAR, SHGC 0.25 WITH U-FACTOR 0.45 (MIN.)

EAST @ INTERIOR COURTYARD

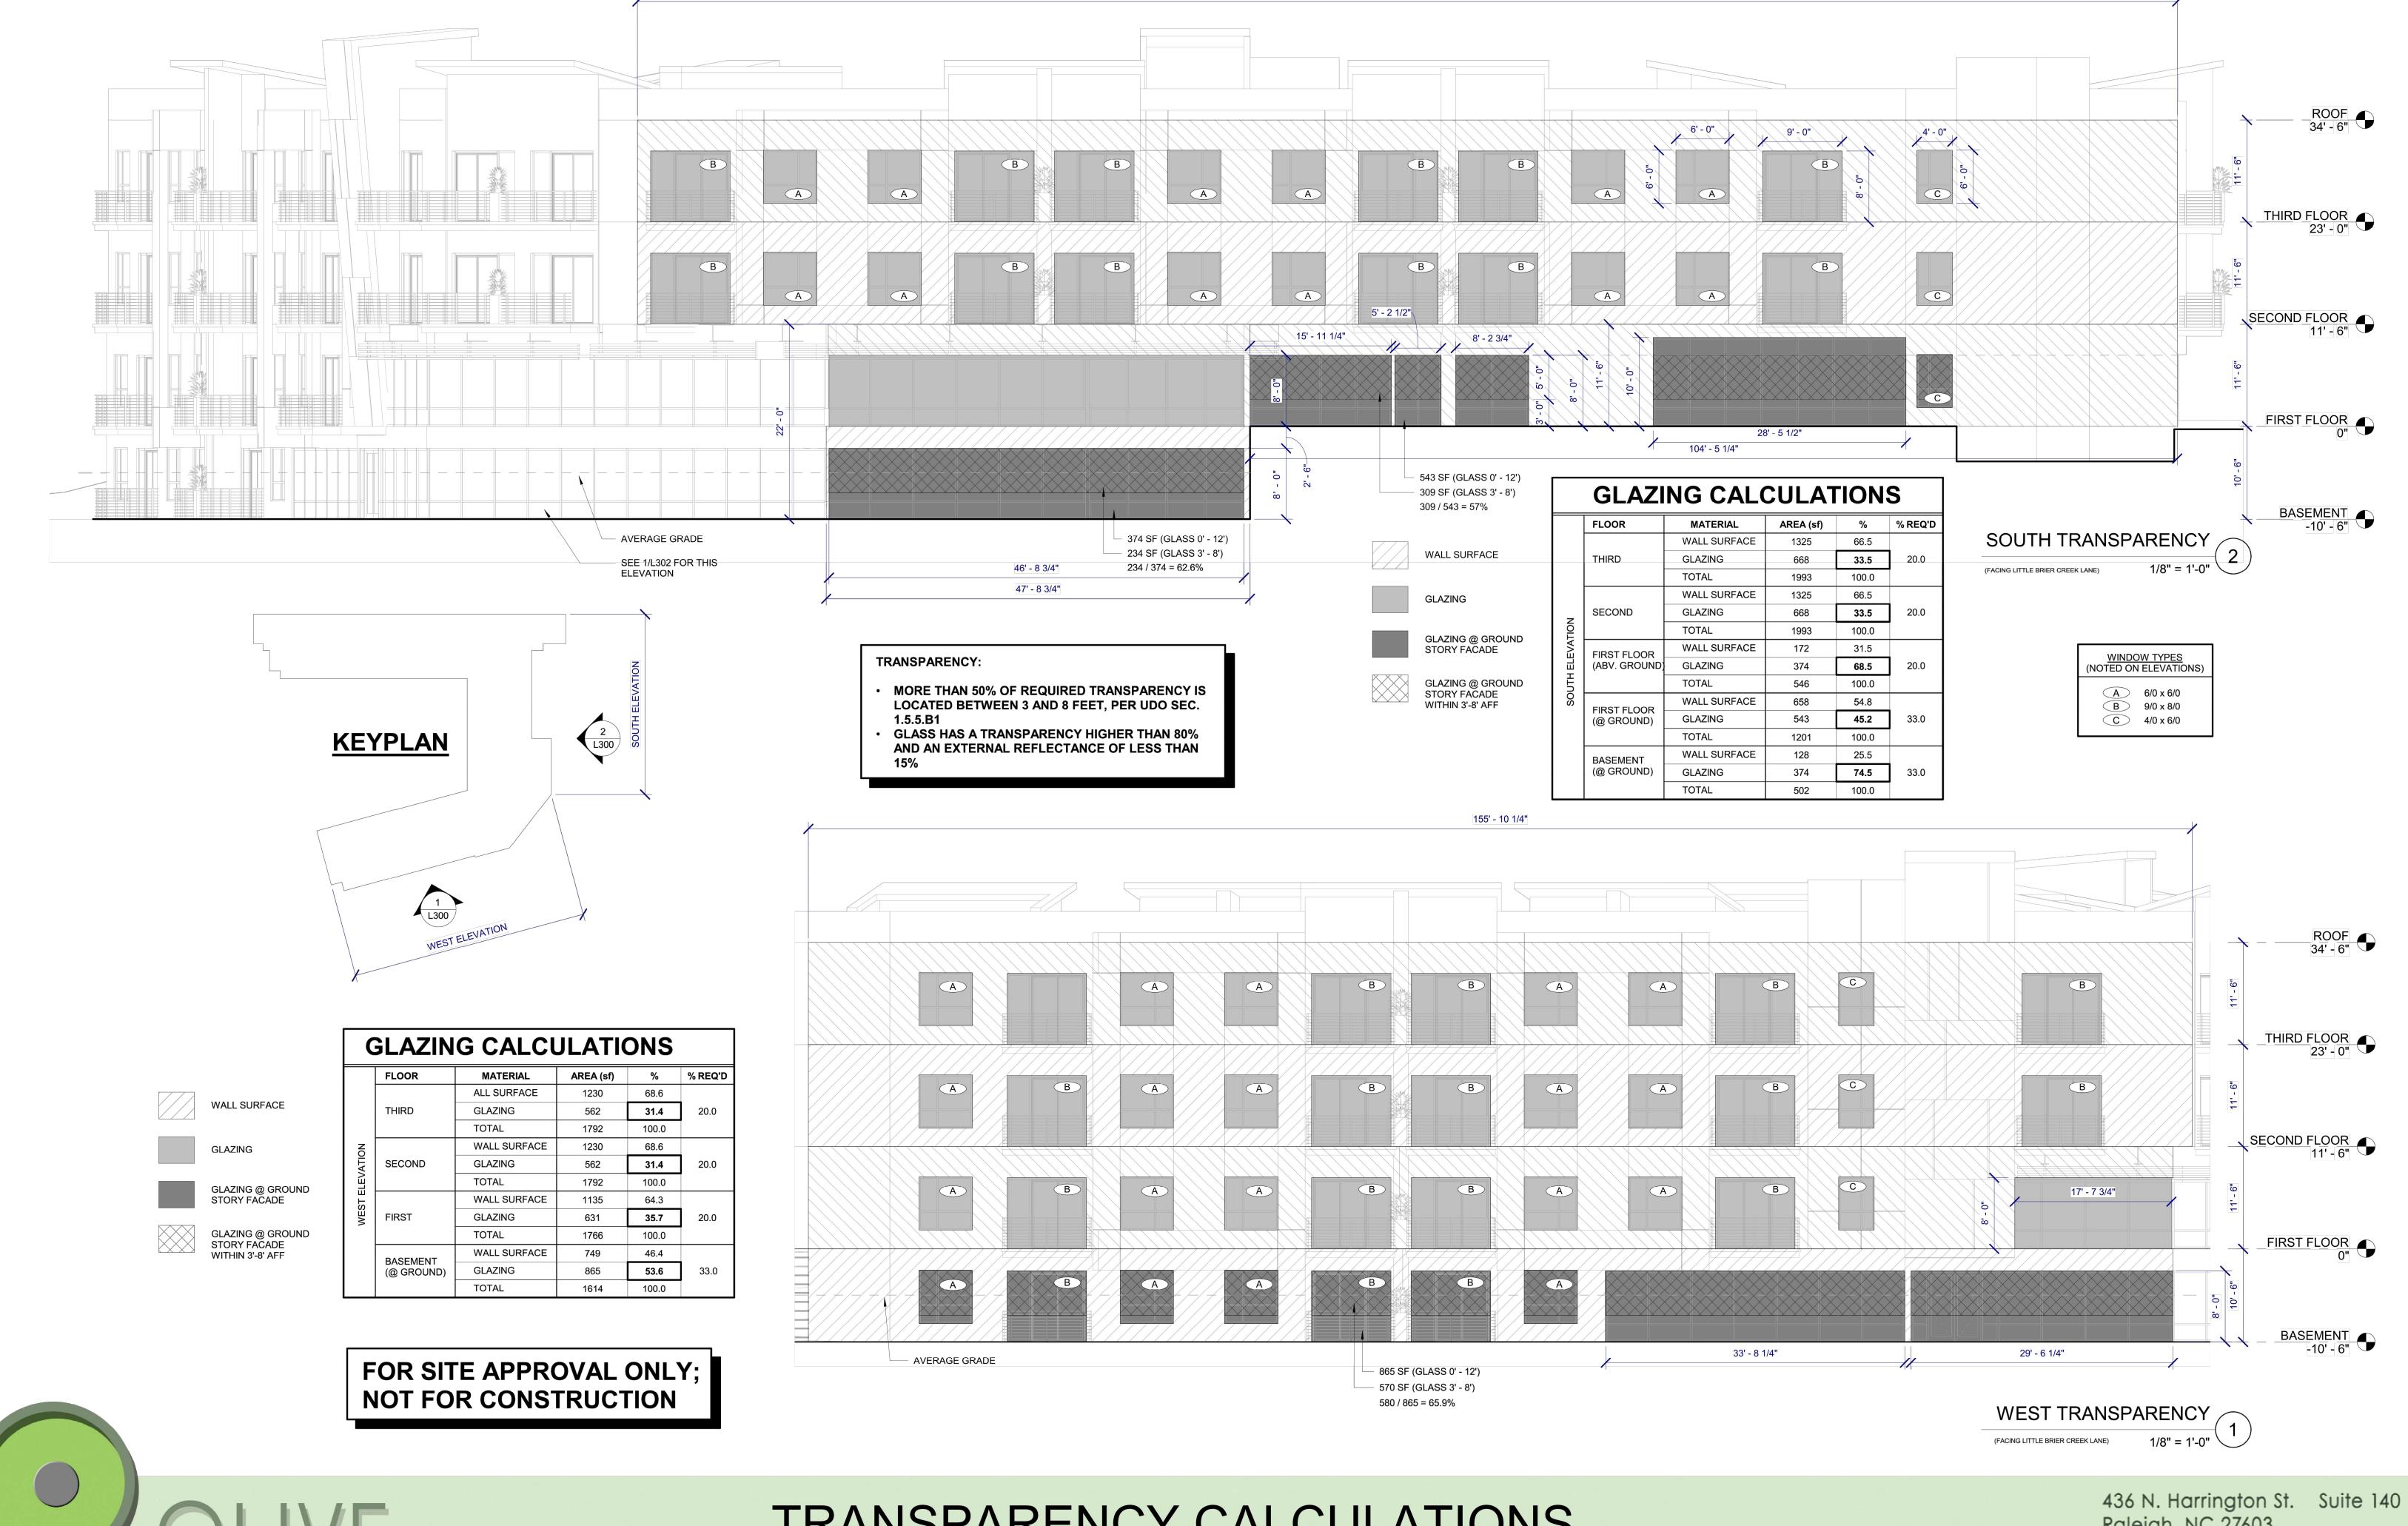
1/8" = 1'-0"

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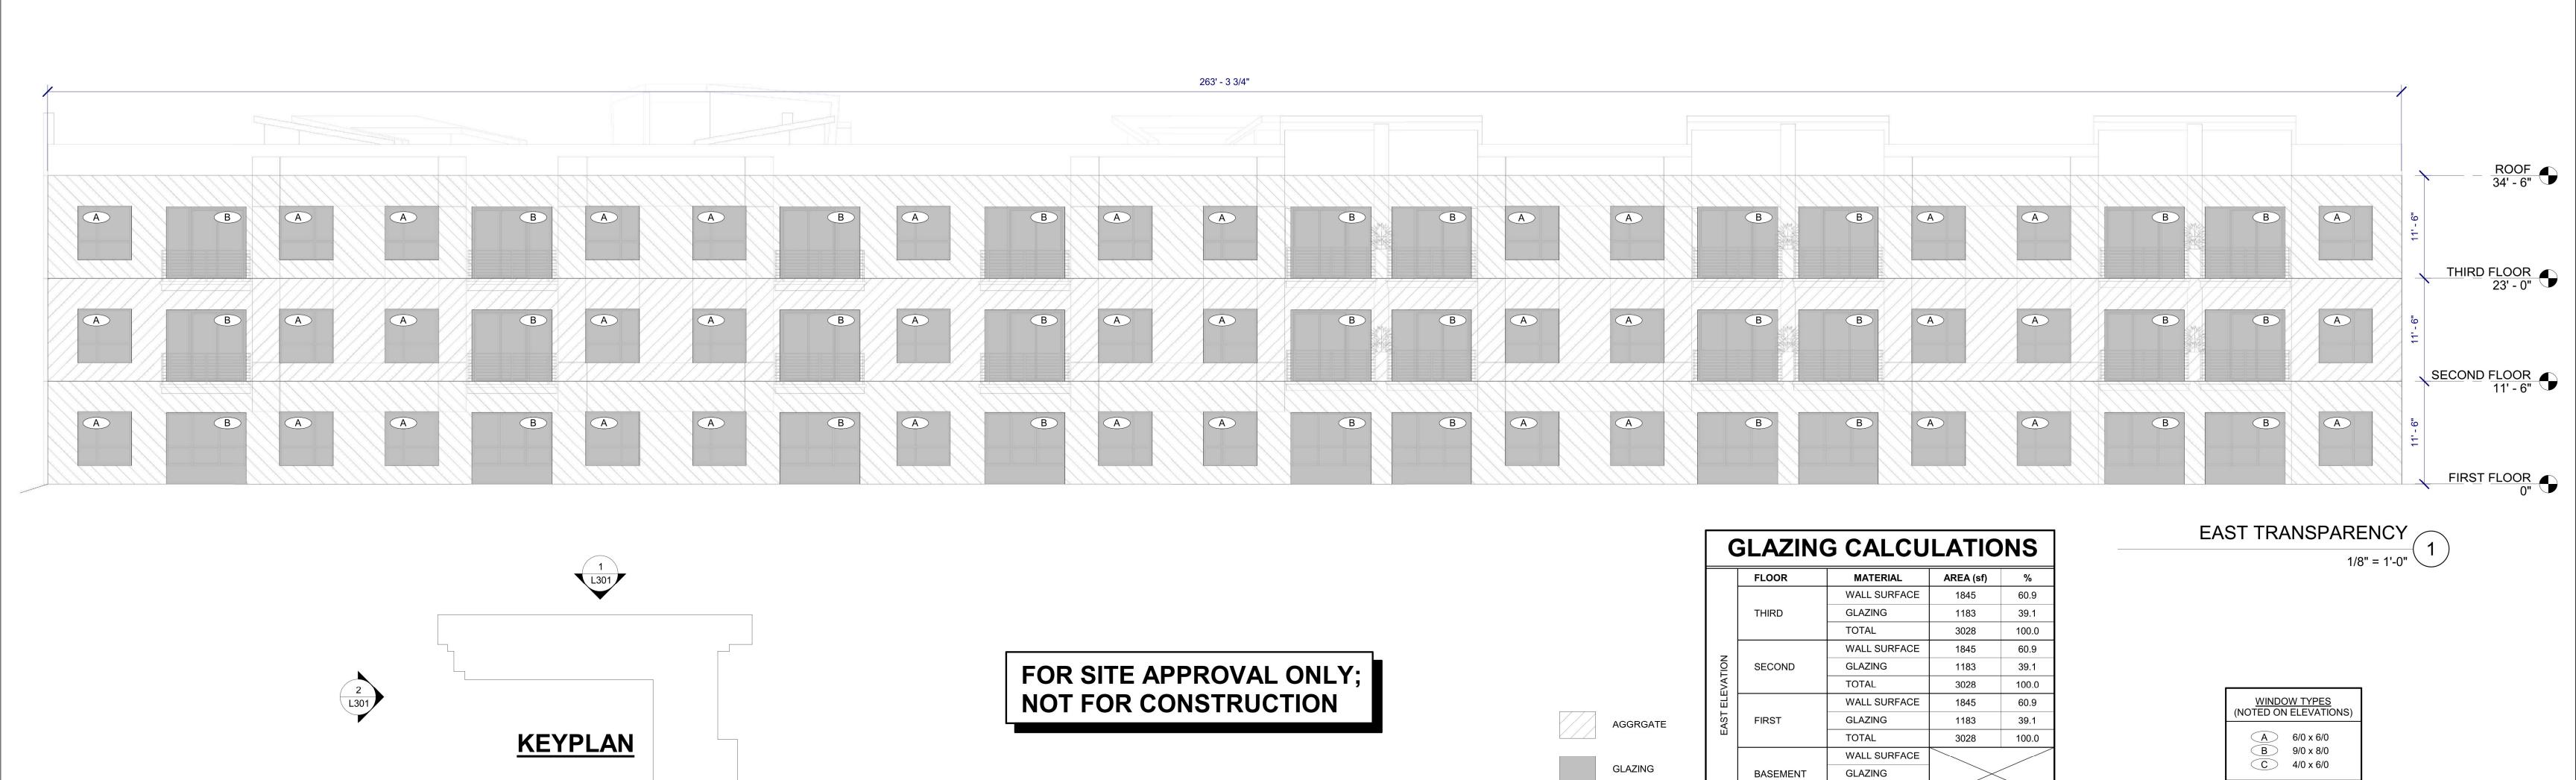


173' - 5 1/4"

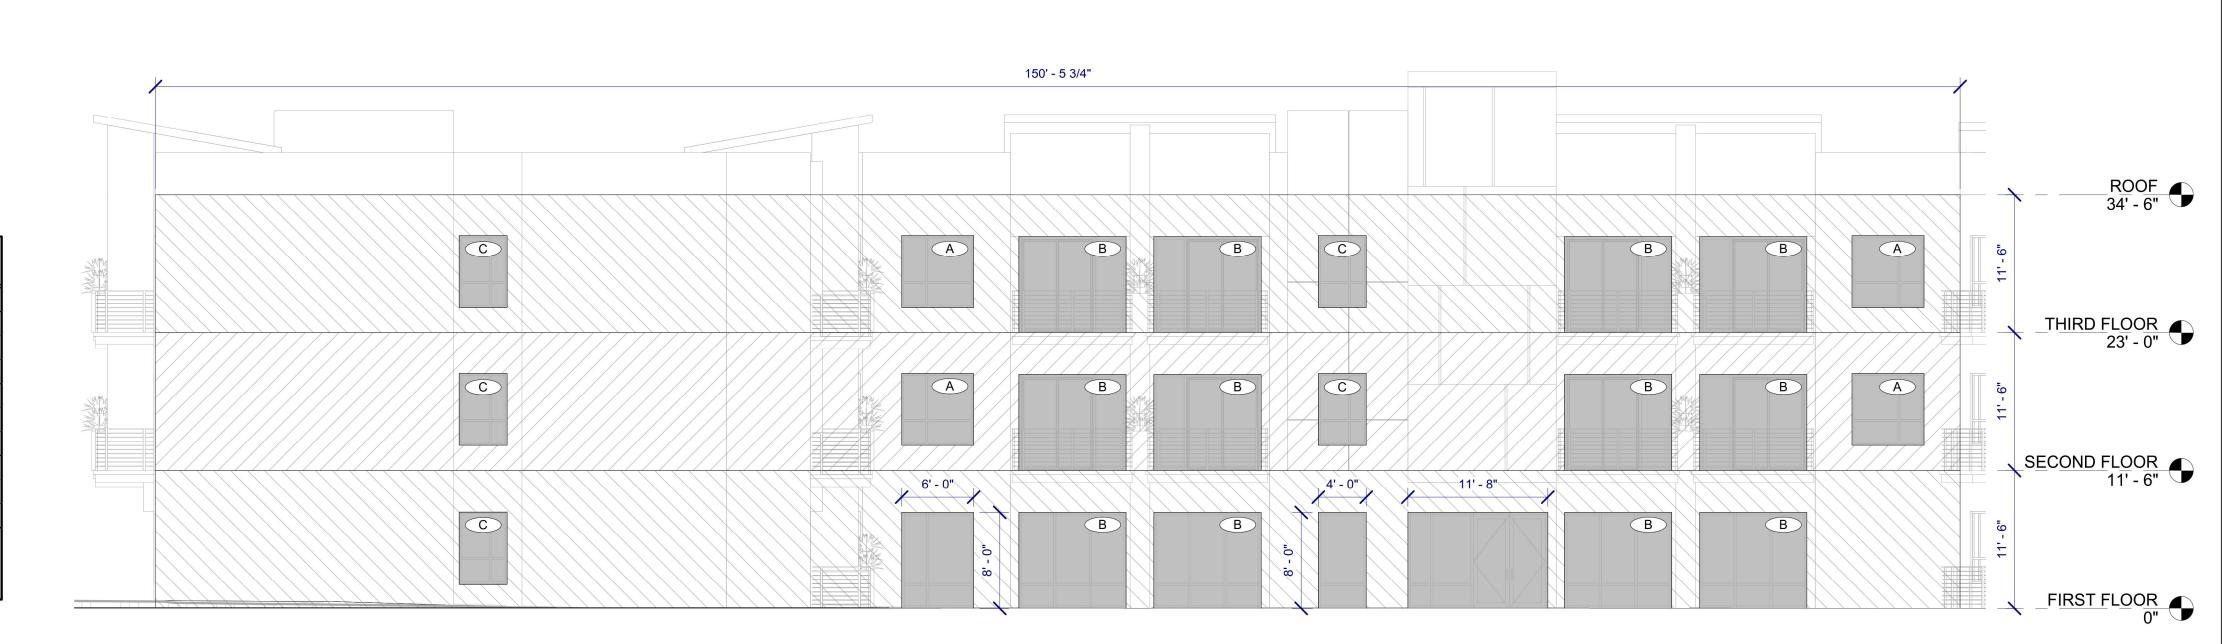
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	SLAZINO	G CALCU	LATIO	NS
	FLOOR	MATERIAL	AREA (sf)	%
		WALL SURFACE	1324	60.9
	THIRD	GLAZING	406	23.5
		TOTAL	1730	100.0
Z	SECOND	WALL SURFACE	1324	60.9
ATIC		GLAZING	406	23.5
LEV		TOTAL	1730	100.0
王	FIRST	WALL SURFACE	1247	72.1
NORTH ELEVATION		GLAZING	483	27.9
Ž		TOTAL	1730	100.0
		WALL SURFACE		
	BASEMENT	GLAZING	$\rightarrow$	
		TOTAL		





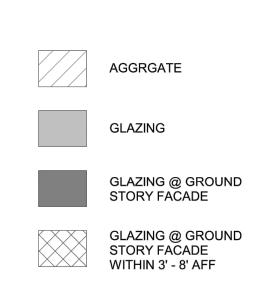
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NORTH TRANSPARENCY

1/8" = 1'-0"

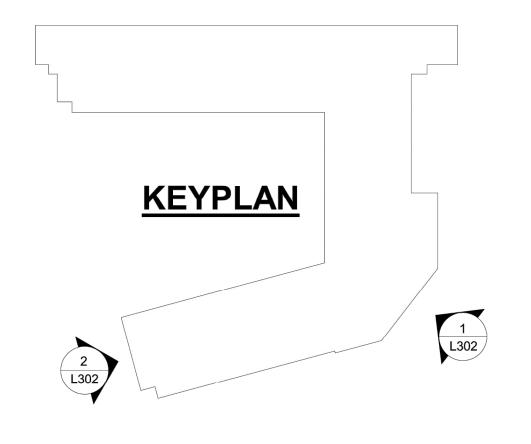
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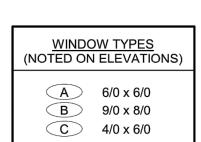
AGGRGATE

GLAZING

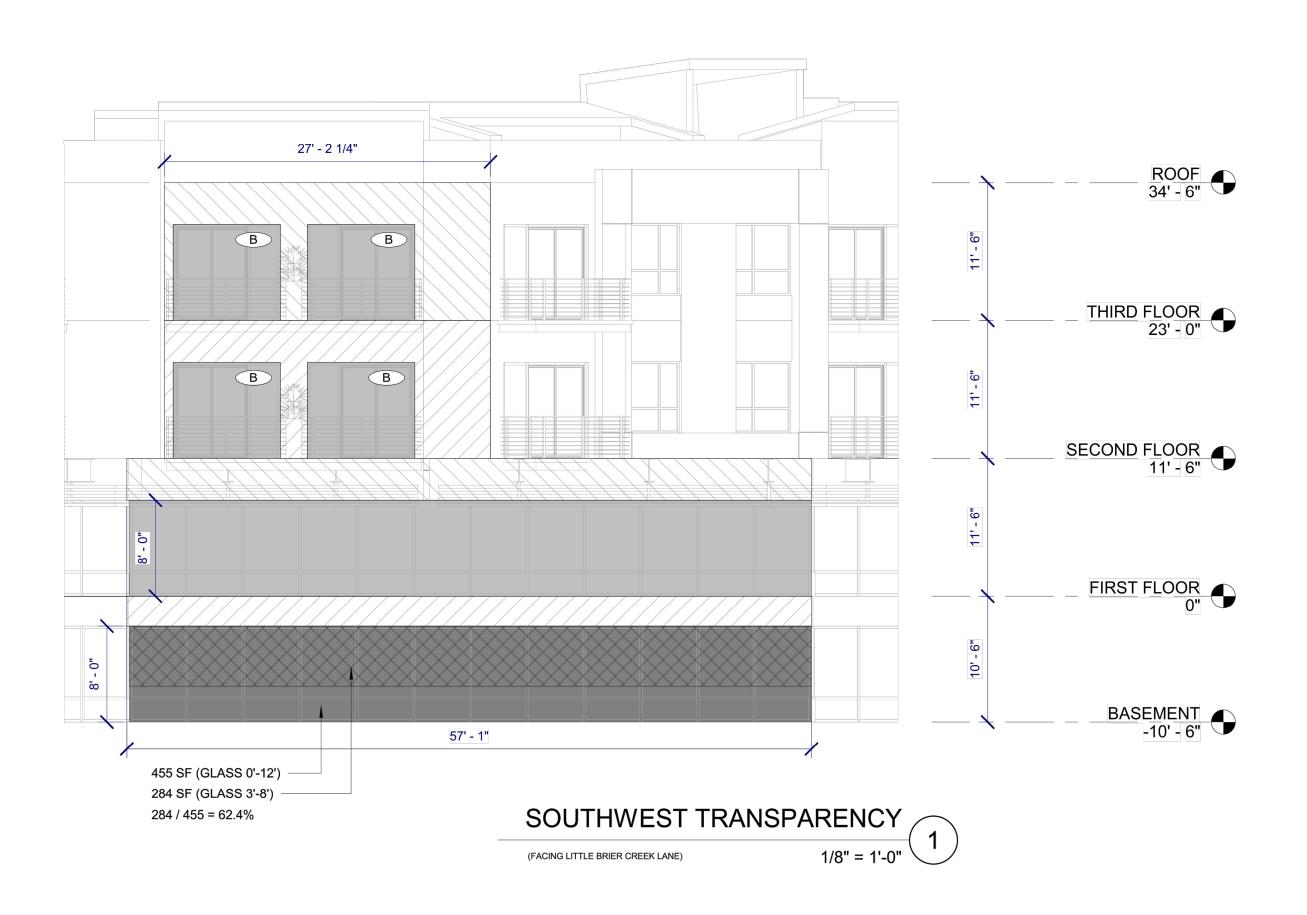
GLAZING CALCULATIONS								
	FLOOR	MATERIAL	AREA (sf)	%	% REQ'D			
SOUTHWEST ELEVATION	THIRD	WALL SURFACE	170	54.3	20.0			
		GLAZING	143	45.7				
		TOTAL	313	100.0				
	SECOND	WALL SURFACE	170	54.3	20.0			
		GLAZING	143	45.7				
		TOTAL	313	100.0				
	FIRST	WALL SURFACE	200	35.1	20.0			
		GLAZING	370	64.9				
		TOTAL	570	100.0				
	BASEMENT (@ GROUND)	WALL SURFACE	143	20.9	33.0			
		GLAZING	540	79.1				
		TOTAL	683	100.0				

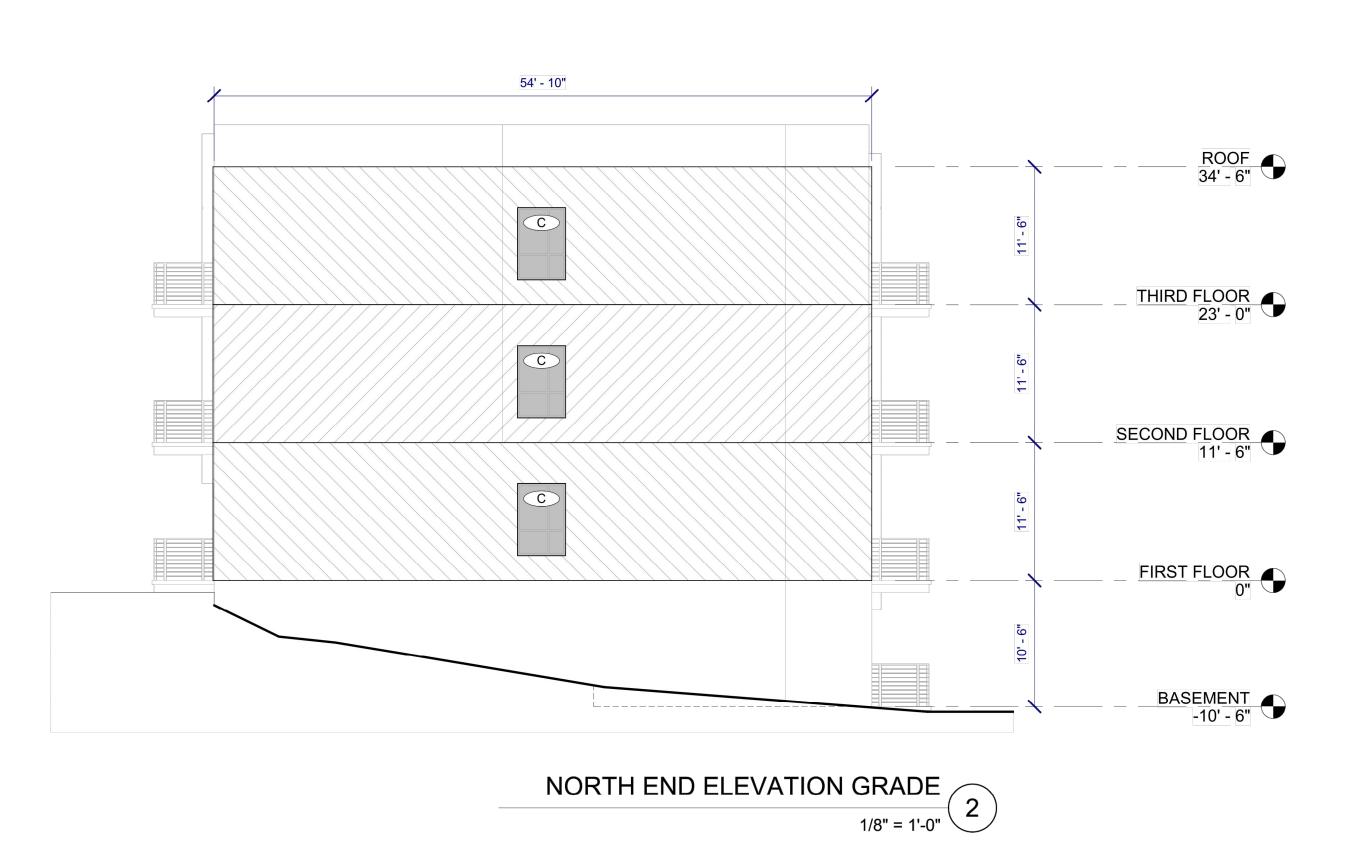


GLAZING CALCULATIONS								
	FLOOR	MATERIAL	AREA (sf)	%				
NORTHWEST ELEVATION	THIRD	WALL SURFACE	608	96.2				
		GLAZING	24	3.8				
		TOTAL	632	100.0				
	SECOND	WALL SURFACE	608	96.2				
		GLAZING	24	3.8				
		TOTAL	632	100.0				
	FIRST	WALL SURFACE	608	96.2				
		GLAZING	24	3.8				
		TOTAL	632	100.0				
	BASEMENT	WALL SURFACE						
		GLAZING	$\rightarrow$					
		TOTAL						





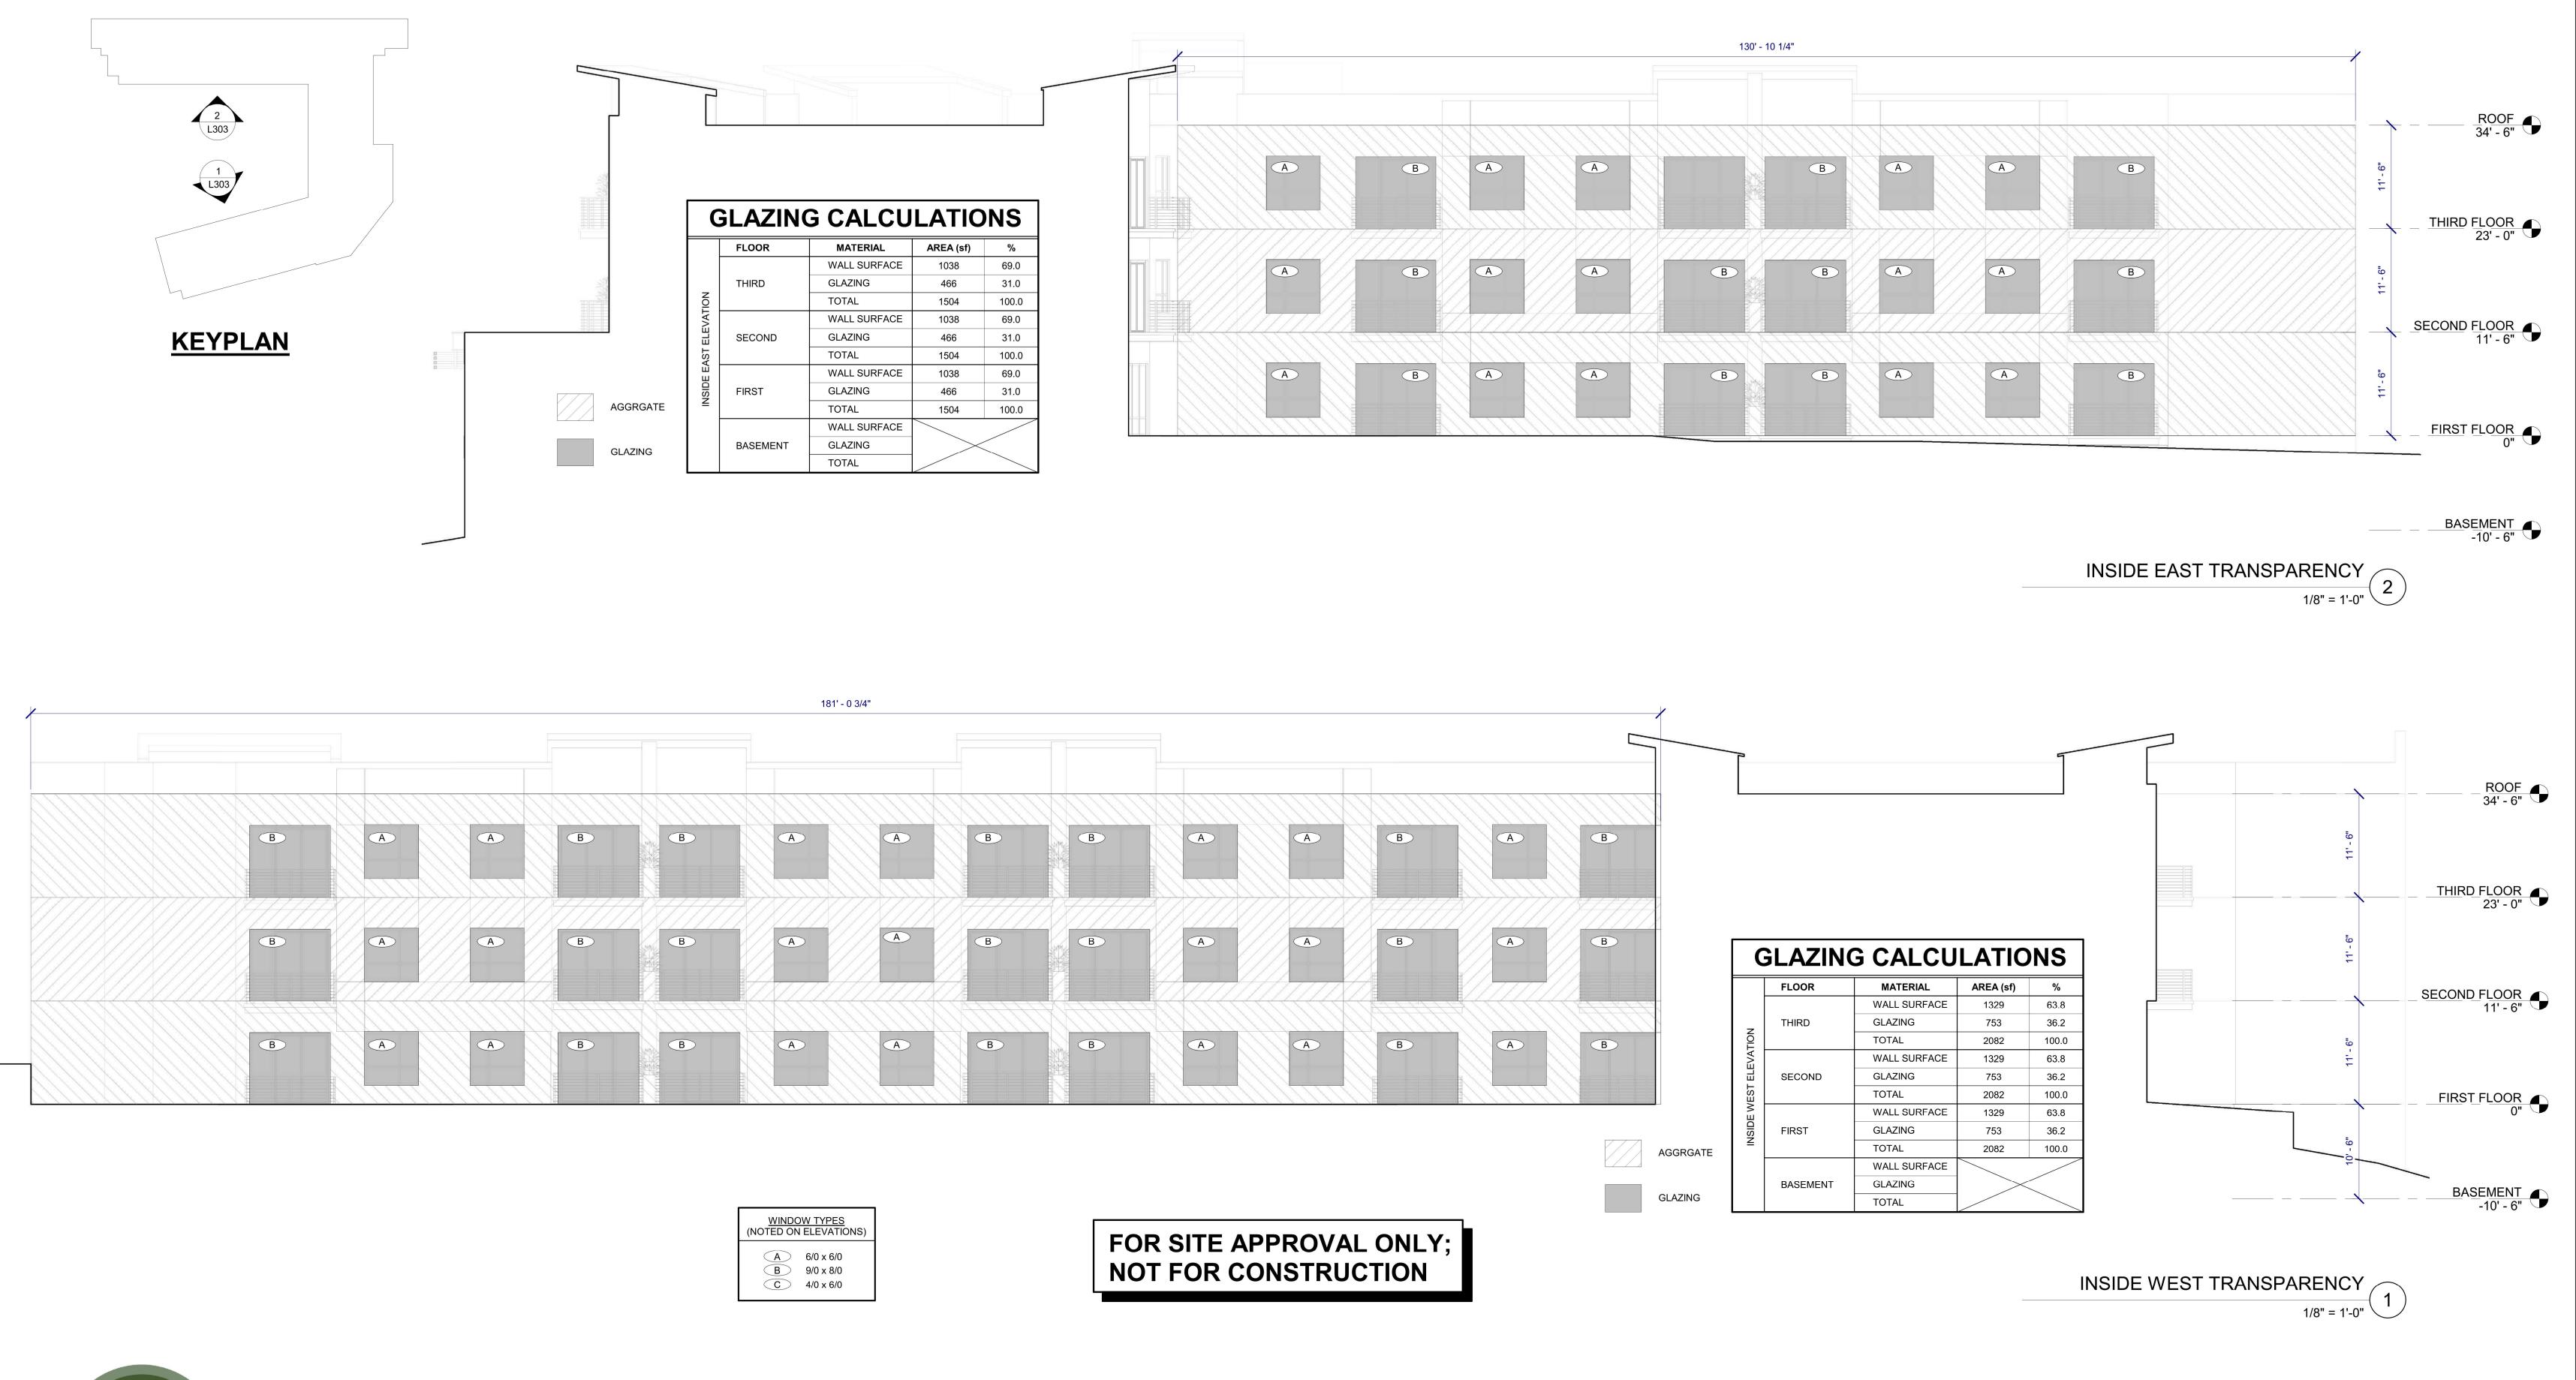






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# TRANSPARENCY CALCULATIONS