

# Administrative Approval Action

SR-108-18 / 502 W. Lenoir Street Transaction# 577517 / AA #3976 City of Raleigh
Development Services Department
One Exchange Plaza
Raleigh, NC 27602
(919) 996-2495
DS.help@raleighnc.gov
www.raleighnc.gov

**LOCATION:** This site is located on the northwest corner of the intersection of W. Lenoir

Street and S. West Street, at 502 W. Lenoir Street.

**REQUEST:** The change of use and addition from a 5,482 square foot auto shop/garage into

a 6,259 square foot restaurant including a building addition and construction of an accessory building, all on a 0.38 acre tract zoned IX-4 UL CU (Z-46-15). Note a previous site plan for a restaurant on this site, case SR-103-16, has

been withdrawn.

DESIGN ADJUSTMENT(S)/ ALTERNATES, ETC:

Two hardship variances have been approved by the City of Raleigh Board of Adjustment for this project, noted below.

1. Relief from the cross-access requirements (8.3.5 d) to the parcel to the north. (A-22-19)

2. Relief from the required parking requirement from 13 spaces to 7 spaces. (A-109-18)

FINDINGS:

City Administration finds that this request, with the below conditions of approval being met, conforms to the Unified Development Ordinance. This approval is based on a preliminary plan dated 05/17/19 by Crumpler Consulting Services, PLLC.

### **CONDITIONS OF APPROVAL and NEXT STEPS:**

This document must be applied to the second sheet of all future submittals except for final plats. This is a preliminary plan and as such no permits have been issued with this approval. To obtain permits and/or completion of the project, the following steps are required:

☑ <u>CONCURRENT SITE REVIEW</u> - For land disturbance of 12,000 square feet or greater, public or private infrastructure, shared stormwater devices, etc. Concurrent Site Review may be submitted upon receipt of this signed approval document.

The following items are required prior to approval of Concurrent Site Review plans:

### **Engineering**

1. A right-of-way obstruction permit must be obtained from Right-of-way Services prior to the commencement of any construction activities within the right-of-way.

#### Stormwater

2. A surety equal to of the cost of clearing, grubbing and reseeding a site, shall be paid to the City (UDO 9.4.4).

SR-108-18, 502 W. Lenoir Street **1** 



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☑ <u>LEGAL DOCUMENTS</u> - Email to <u>legaldocumentreview@raleighnc.gov</u>. Legal documents must be approved, executed, and recorded prior to or in conjunction with the recorded plat on which the associated easements are shown. Copies of recorded documents must be returned to the City within one business day of recording to avoid withholding of further permit issuance.

	City Code Covenant	Slope Easement
	Stormwater Maintenance	Transit Easement
	Covenant	
	Utility Placement Easement	Cross Access Easement
$\boxtimes$	Sidewalk Easement	Public Access Easement
		Other:

☑ BUILDING PERMITS – For buildings and structures shown on the approved plans. Commercial building permit plans must include the signed, approved Concurrent Site Review plans attached, if applicable. Permit sets may be reviewed prior to the recordation of required plats, but cannot be approved.

The following items must be approved prior to the issuance of building permits:

#### General

- 1. Comply with all conditions of Z-46-15.
- 2. Provide fire flow analysis.

### **Engineering**

- 3. The required right of way for proposed and/or existing streets shall be dedicated to the City of Raleigh and is shown on a plat approved for recordation.
- 4. A public infrastructure surety shall be provided to the City of Raleigh Development Services Development Engineering (UDO 8.1.3).
- 5. A sidewalk deed of easement for any public sidewalk on private property shall be approved by City staff, and the location of the easement shall be shown on the map approved for recordation. The deed of easement shall be recorded at Wake County Register of Deeds within one day of recordation of the plat. A recorded copy of this document shall be provided to the Development Services Department within one day from authorization of lot recordation. If a recorded copy of the document is not provided, further recordings and building permit issuance will be withheld.
- 6. A right-of-way obstruction permit shall be obtained from Right-of-way Services for any construction activity within the right-of-way.

#### **Public Utilities**

7. A plat must be recorded at the Wake County Register of Deeds office for all utility easement dedications.

SR-108-18, 502 W. Lenoir Street **2** 



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8. Proposed 2" water meter must be within the right of way or dedicated easement entitled "City of Raleigh Water Line Easement"

### **Urban Forestry**

9. A tree impact permit must be obtained for the approved streetscape tree installation in the right of way. This development proposes four street trees along W Lenoir St, five street trees along S West

### The following are required prior to issuance of building occupancy permit:

- 1. All Water, Sanitary Sewer and Reuse facilities shall be installed, inspected, tested and accepted by the City of Raleigh Public Utilities Department for operations and maintenance.
- Required public right-of-way infrastructure improvements shall be, at a minimum, sufficiently completed to provide the necessary, safe emergency and vehicular access.
- 3. All street lights and street signs required as part of the development approval are installed.
- 4. Copies of certified inspection reports for alleys and internal access ways are submitted to the City of Raleigh Development Services - Development Engineering program.
- 5. Final inspection of all right of way street trees by Urban Forestry Staff.

EXPIRATION DATES: The expiration provisions of UDO Section 10.2.8 E, including the ability to request extensions in the expiration date, apply to this site plan. If significant construction has not taken place on a project after administrative site review approval, that approval may expire and be declared void, requiring reapproval before permits may be issued. To avoid allowing this plan approval to expire the following must take place by the following dates:

3-Year Expiration Date: 5-29-2022

Obtain a valid building permit for the total area of the project, or a phase of the project.

4-Year Completion Date:

Within four years after issuance of the first building permit for the site plan, the construction of the entire site plan must be completed unless an applicant has been granted vested rights. Failure to complete construction within this specified time frame shall automatically void the approved site plan for which no building permits have been issued.


for little

I hereby certify this administrative decision.

Signed:(Development Services Dir./Designee)

Staff Coordinator: Michael Walters

Date: 5/29/19

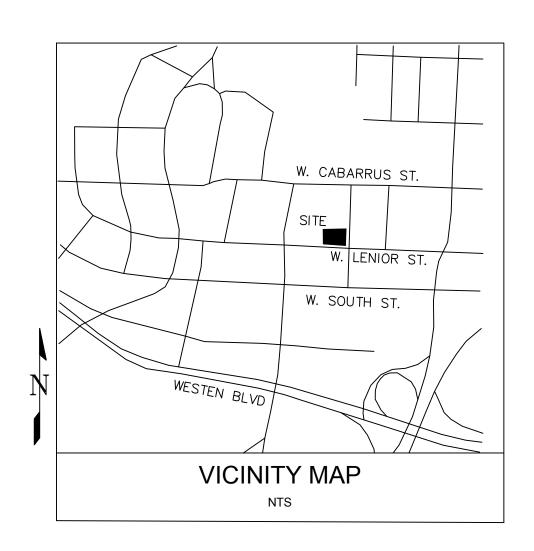

### **Administrative Site Review Application** (for UDO Districts only)

nent Services Customer Service Center | 1 Exchange Plaza, Suite 400 | Raleigh, NC 27601 | 919-996-2495 | efax 919-996-183 Litchford Satellite Office | 8320 – 130 Litchford Road | Raleigh, NC 27601 | 919-996-4200

When sub	mitting plans, please check the appropriate building type and include	the Plan Checklist document.					
	BUILDING TYPE	FOR OFFICE USE ONLY					
Detached Attached Apartment Townhouse	General  Mixed Use  Open Lot	Transaction Number  Assigned Project Coordinator  Assigned Team Leader					
Has your project previou	sly been through the <b>Due Diligence or Sketch Plan Review</b> process? If yes, pr	ovide the transaction #					
	GENERAL INFORMATION						
	02 W. Lenoir Street						
Zoning District  X-4	-UL-CU Overlay District (if applicable)	nside City Limits? Yes $\square_{No}$					
Proposed Use Resta	urant						
Property Address(es) 50	02 W. Lenoir Street Major Street Lo	cator:					
Wake County Property lo	dentification Number(s) for each parcel to which these guidelines will apply:						
P.I.N. 1703-46-80	P.I.N. 1703-46-8600 P.I.N. P.I.N. P.I.N.						
What is your project type?  Mixed Residential  Duplex  Other: If other, please d	Non-Residential Condo ☐ School ☐ Religious Institutions ☐ Residential Condo	☐ Hotels/Motels ☐ Office ☐ Banks ☐ Industrial Building ☐ Retail ☐ Cottage Court					
WORK SCOPE	Per City Code Section 10.2.8.D.1, summarize the project work scope. For additions, changes of use, or occupancy (per Chapter 6 of the UDO), indicate impacts on parking requirements.  Change of Use and remodel of existing building from a garage to a restaurant.						
DESIGN ADJUSTMENT OR ADMIN ALTERNATE	I Administrative AF						
es and the many offer	Company SILVERPLATE PROPERTIES, LLC Name (s) James Goodnight						
CLIENT/DEVELOPER/ OWNER	Address 801 Oberlin Road, Suite 335						
	Phone 919-821-1350 Email james.goodnight@sas.com Fax 919-828-9240						
CONSULTANT	Company Crumpler Consulting Services, PLLC Name (s) Josh Crumpler						
(Contact Person for	Address 2308 Ridge Road, Raleigh, NC 27612						
Plans)	Phone 919-413-1704 Email josh@crumplercons	sulting.com Fax					
PAGE 1 OF 3	WWW.RALEIGHNC.GOV	REVISION 05.13.16					

DEVELOPMENT TYPE & SITE DATA 1	ABLE (Applicable to all developments)
Zoning Information	Building Information
Zoning District(s) Industrial Mixed Use (IX-4-UL-CU)	Proposed building use(s) Restaurant
If more than one district, provide the acreage of each:	Existing Building(s) sq. ft. gross 5,084
Overlay District	Proposed Building(s) sq. ft. gross 1,000
Total Site Acres Inside City Limits ■ Yes □ No .38	Total sq. ft. gross (existing & proposed) 6,084
Off street parking: Required 13 Provided 9	Proposed height of building(s)
COA (Certificate of Appropriateness) case #	# of stories 1 - 2 , EXISTING
BOA (Board of Adjustment) case # A-	Ceiling height of 1st Floor - garage C.H. 17'-0'
CUD (Conditional Use District) case # Z-	
Stormwate	r Information
Existing Impervious Surface 11,100/0.25 acres/square feet	Flood Hazard Area Yes No
Proposed Impervious Surface 13, 152/0.30 acres/square feet	If Yes, please provide:
Neuse River Buffer ☐ Yes ☐ No Wetlands ☐ Yes ☐ No	Alluvial Soils Flood Study FEMA Map Panel #
FOR RESIDENTIA	AL DEVELOPMENTS
1. Total # Of Apartment, Condominium or Residential Units	5. Bedroom Units: 1br 2br 3br 4br or more
2. Total # Of Congregate Care Or Life Care Dwelling Units	6. Infill Development 2.2.7
3. Total Number of Hotel Units	7. Open Space (only) or Amenity
4. Overall Total # Of Dwelling Units (1-6 Above)	8. Is your project a cottage court?
SIGNATURE BLOCK (App	icable to all developments)
In filing this plan as the property owner(s), I/we do hereby agree and fir and assigns jointly and severally to construct all improvements and make approved by the City.  I hereby designate  Joshua Crumpler  receive and respond to administrative comments, to resubmit plans on application.	e all dedications as shown on this proposed development plan as to serve as my agent regarding this application, to
use.	to all application requirements applicable with the proposed development
	Date 1/30/16
Printed Name James Goodnight	
•	
Signed	Date

**REVISION 05.13.16** 

ADMINISTRATIVE SITE PLAN

FOR

# 502 W. LENOIR STREET RALEIGH, NORTH CAROLINA

CITY OF RALEIGH FILE: SR-XXX-XX CITY OF RALEIGH TRANSACTION #: XXXXXXX

# PREPARED FOR:

SILVERPLATE PROPERTIES, LLC 801 OBERLIN ROAD, SUITE 335 RALEIGH, NC 27605

# PREPARED BY: CRUMPLER Consulting Services, PLLC

2308 Ridge Road Raleigh, North Carolina 27612 Ph. 919-413-1704

DESCRIPTION COVER

**ZONING NOTES** 

**EXISTING CONDITIONS PLAN** 

SITE PLAN

SHEET

UTILITY PLAN

**GRADING AND** 

STORMDRAINAGE PLAN LANDSCAPING PLAN

D-1 **DETAILS** 


**DETAILS** 

ALL CONSTRUCTION TO BE IN ACCORDANCE WITH ALL CITY OF RALEIGH STANDARDS AND SPECIFICATIONS.

> CALL 48 HOURS BEFORE YOU DIG



NORTH CAROLINA **ONE-CALL CENTER** 1-800-632-4949

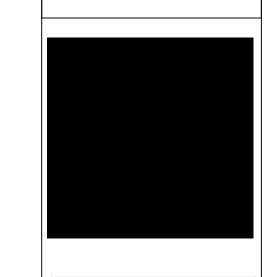

**ISSUED FOR** 

	PERMITTING				
	DATE				
	DESCRIPTION				
SITE EXEMPTION NOTES:	DE				
-THE SITE WILL BE CONFORMING TO THE EXEMPTION OF TREE CONSERVATION REQUIREMENTS THROUGH THE CITY OF RALEIGH'S UNIFIED DEVELOPMENT CODE SECTION 9.1.2 FOR PARCELS LESS THAN 2 ACRES IN SIZE.					
	REV.				


COVER SHEET

PROJECT NO.: 501 DRAWN BY: JAC

CHECKED BY: JAC 11/15/18 NOT TO SCALE

C-1

1 of 9

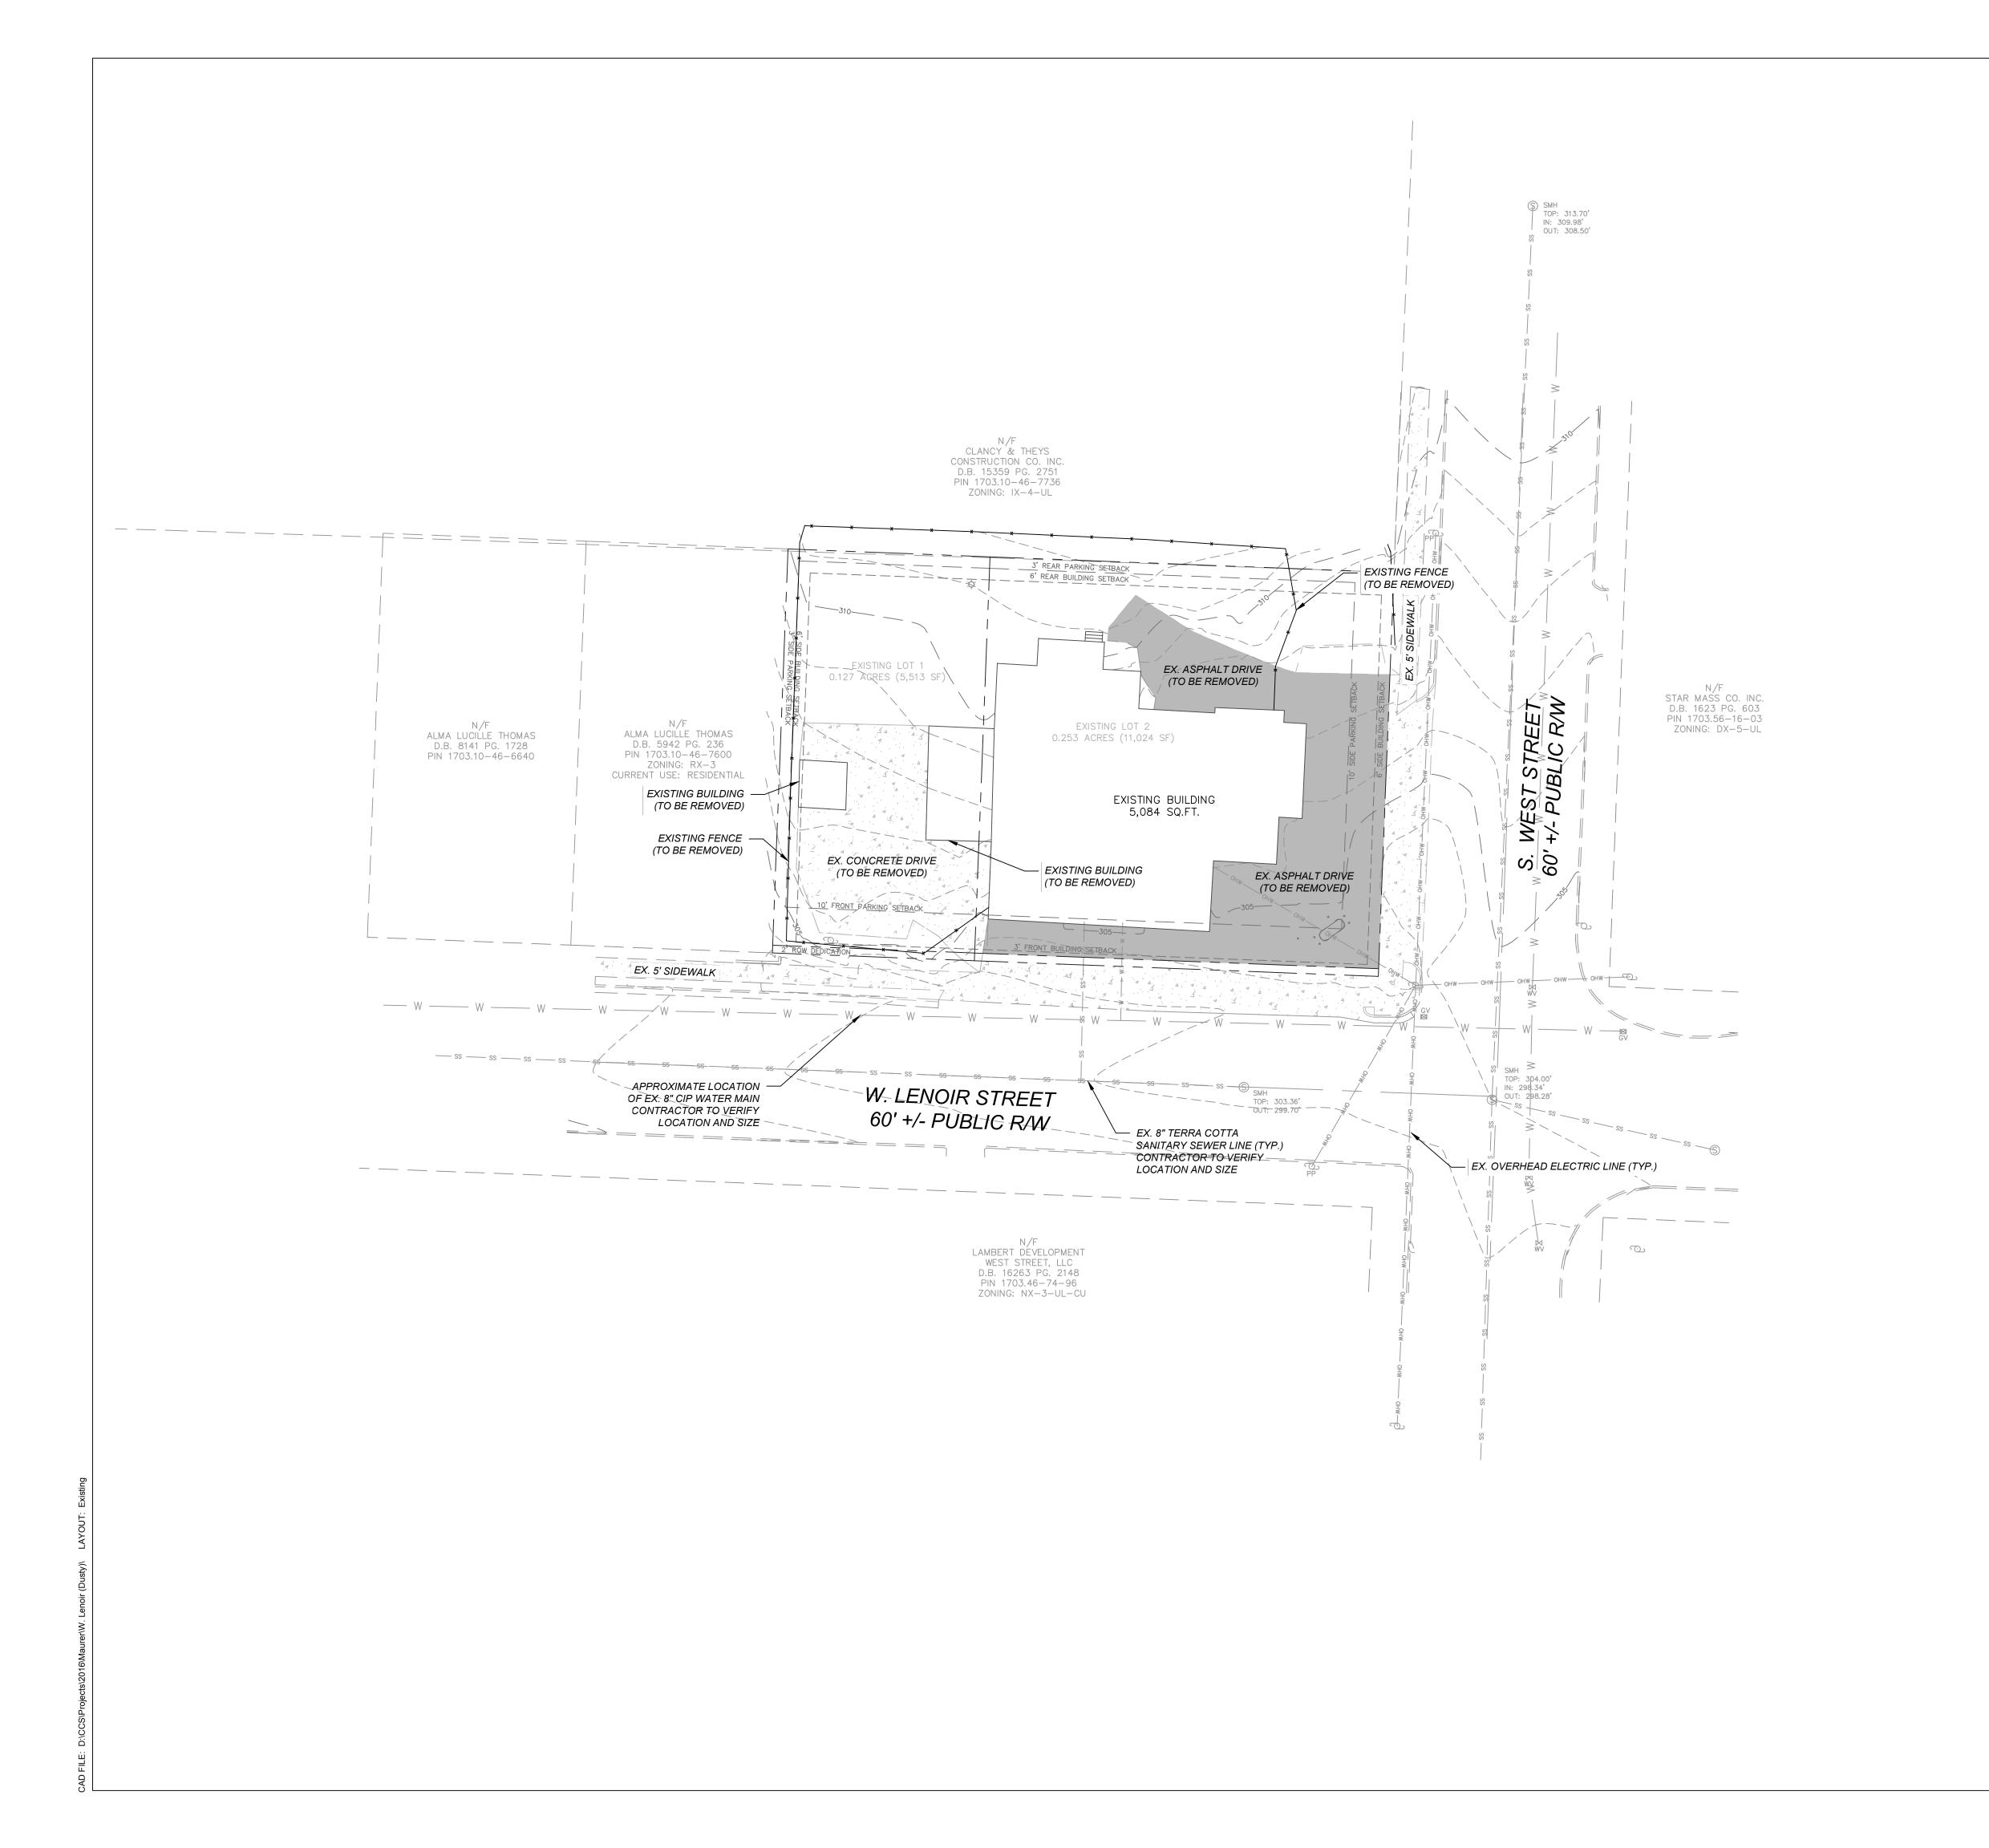


# LEGEND

EXISTING PROPERTY LINE
EXISTING ABUTTING PROPERTY LINE
EXISTING RIGHT-OF-WAY
OHW—OHW—OHW—OHW—OHW—EXISTING OVERHEAD POWER LINE
EXISTING ABUTTING PROPERTY LINE
EXISTING ABUTTING PROPERTY LINE
EXISTING BUILDING SETBACK LINE
EXISTING PARKING SETBACK LINE
EXISTING PARKING SETBACK LINE
EXISTING EDGE OF PAVEMENT
EXISTING EDGE OF PAVEMENT
EXISTING SANITARY SEWER

# <u>NOTES</u>

- TOPOGRAPHIC AND BOUNDARY SURVEY PROVIDED BY CAWTHORNE, MOSS, & PANCIERA, DATED 05-03-2016.
- 2. PROPERTY IS LOCATED IN ZONES X (AREA DETERMINED TO BE OUTSIDE THE O.2% ANNUAL CHANCE AND FUTURE 1% ANNUAL CHANCE FLOODPLAIN) BASED ON THE FEMA MAP NUMBER 3720170300J DATED MAY 2, 2006.
- NO ONSITE STREAMS OR WETLANDS HAVE BEEN IDENTIFIED WITHIN THE PROJECT OR PARCEL AS SHOWN.
- 4. A DEMOLITION PLAN WILL BE REQUIRED AS A CONDITION OF APPROVAL
- 5. PARCELS WILL BE RECOMBINED PRIOR TO ISSUANCE OF BUILDING PERMITS.

Raleigh, North Carolina 27612
Ph. 919-413-1704

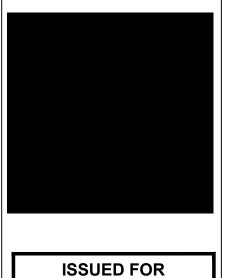

**PERMITTING** 

DATE			
DESCRIPTION			
REV.			

EXISTING CONDITIONS
502 W. LENOIR STREET
502 W. LENOIR STREET

PROJECT NO.: 501

DRAWN BY: JAC

CHECKED BY: JAC


DATE: 11/15/18


SCALE: 1" = 20'

20 10 0 20 SCALE: 1 INCH = 20 FEET

C-3

3 of 9

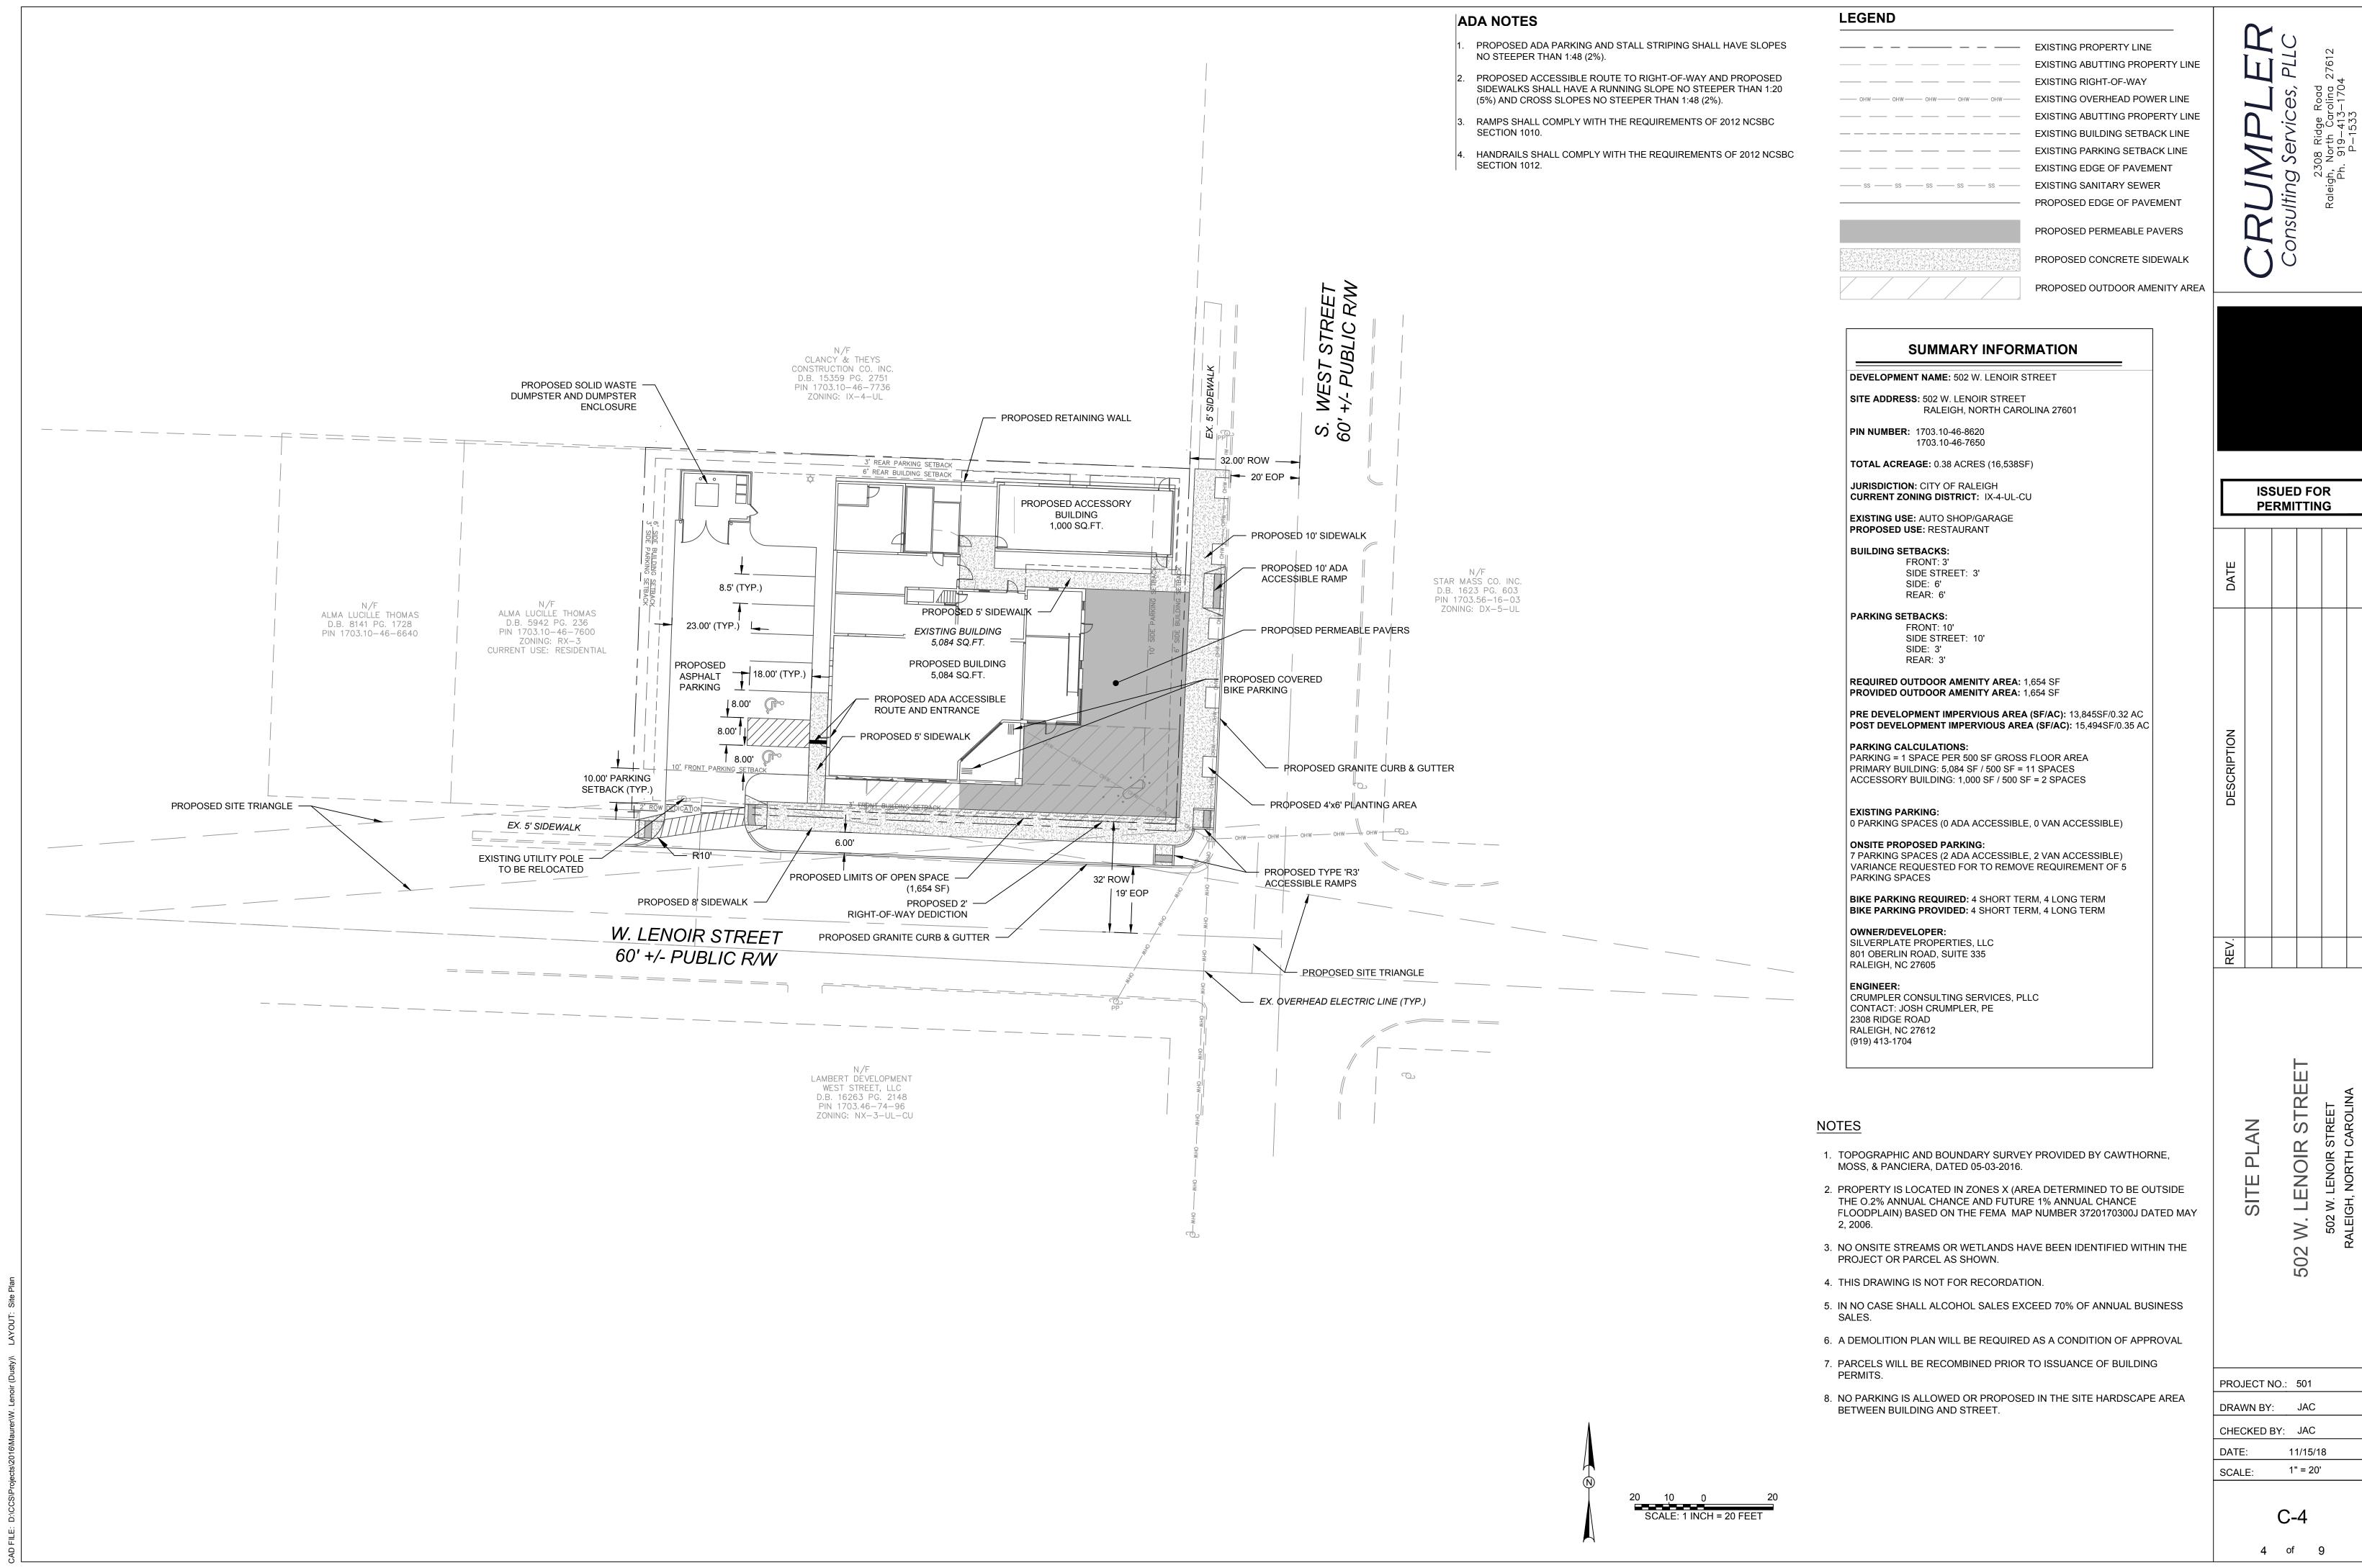

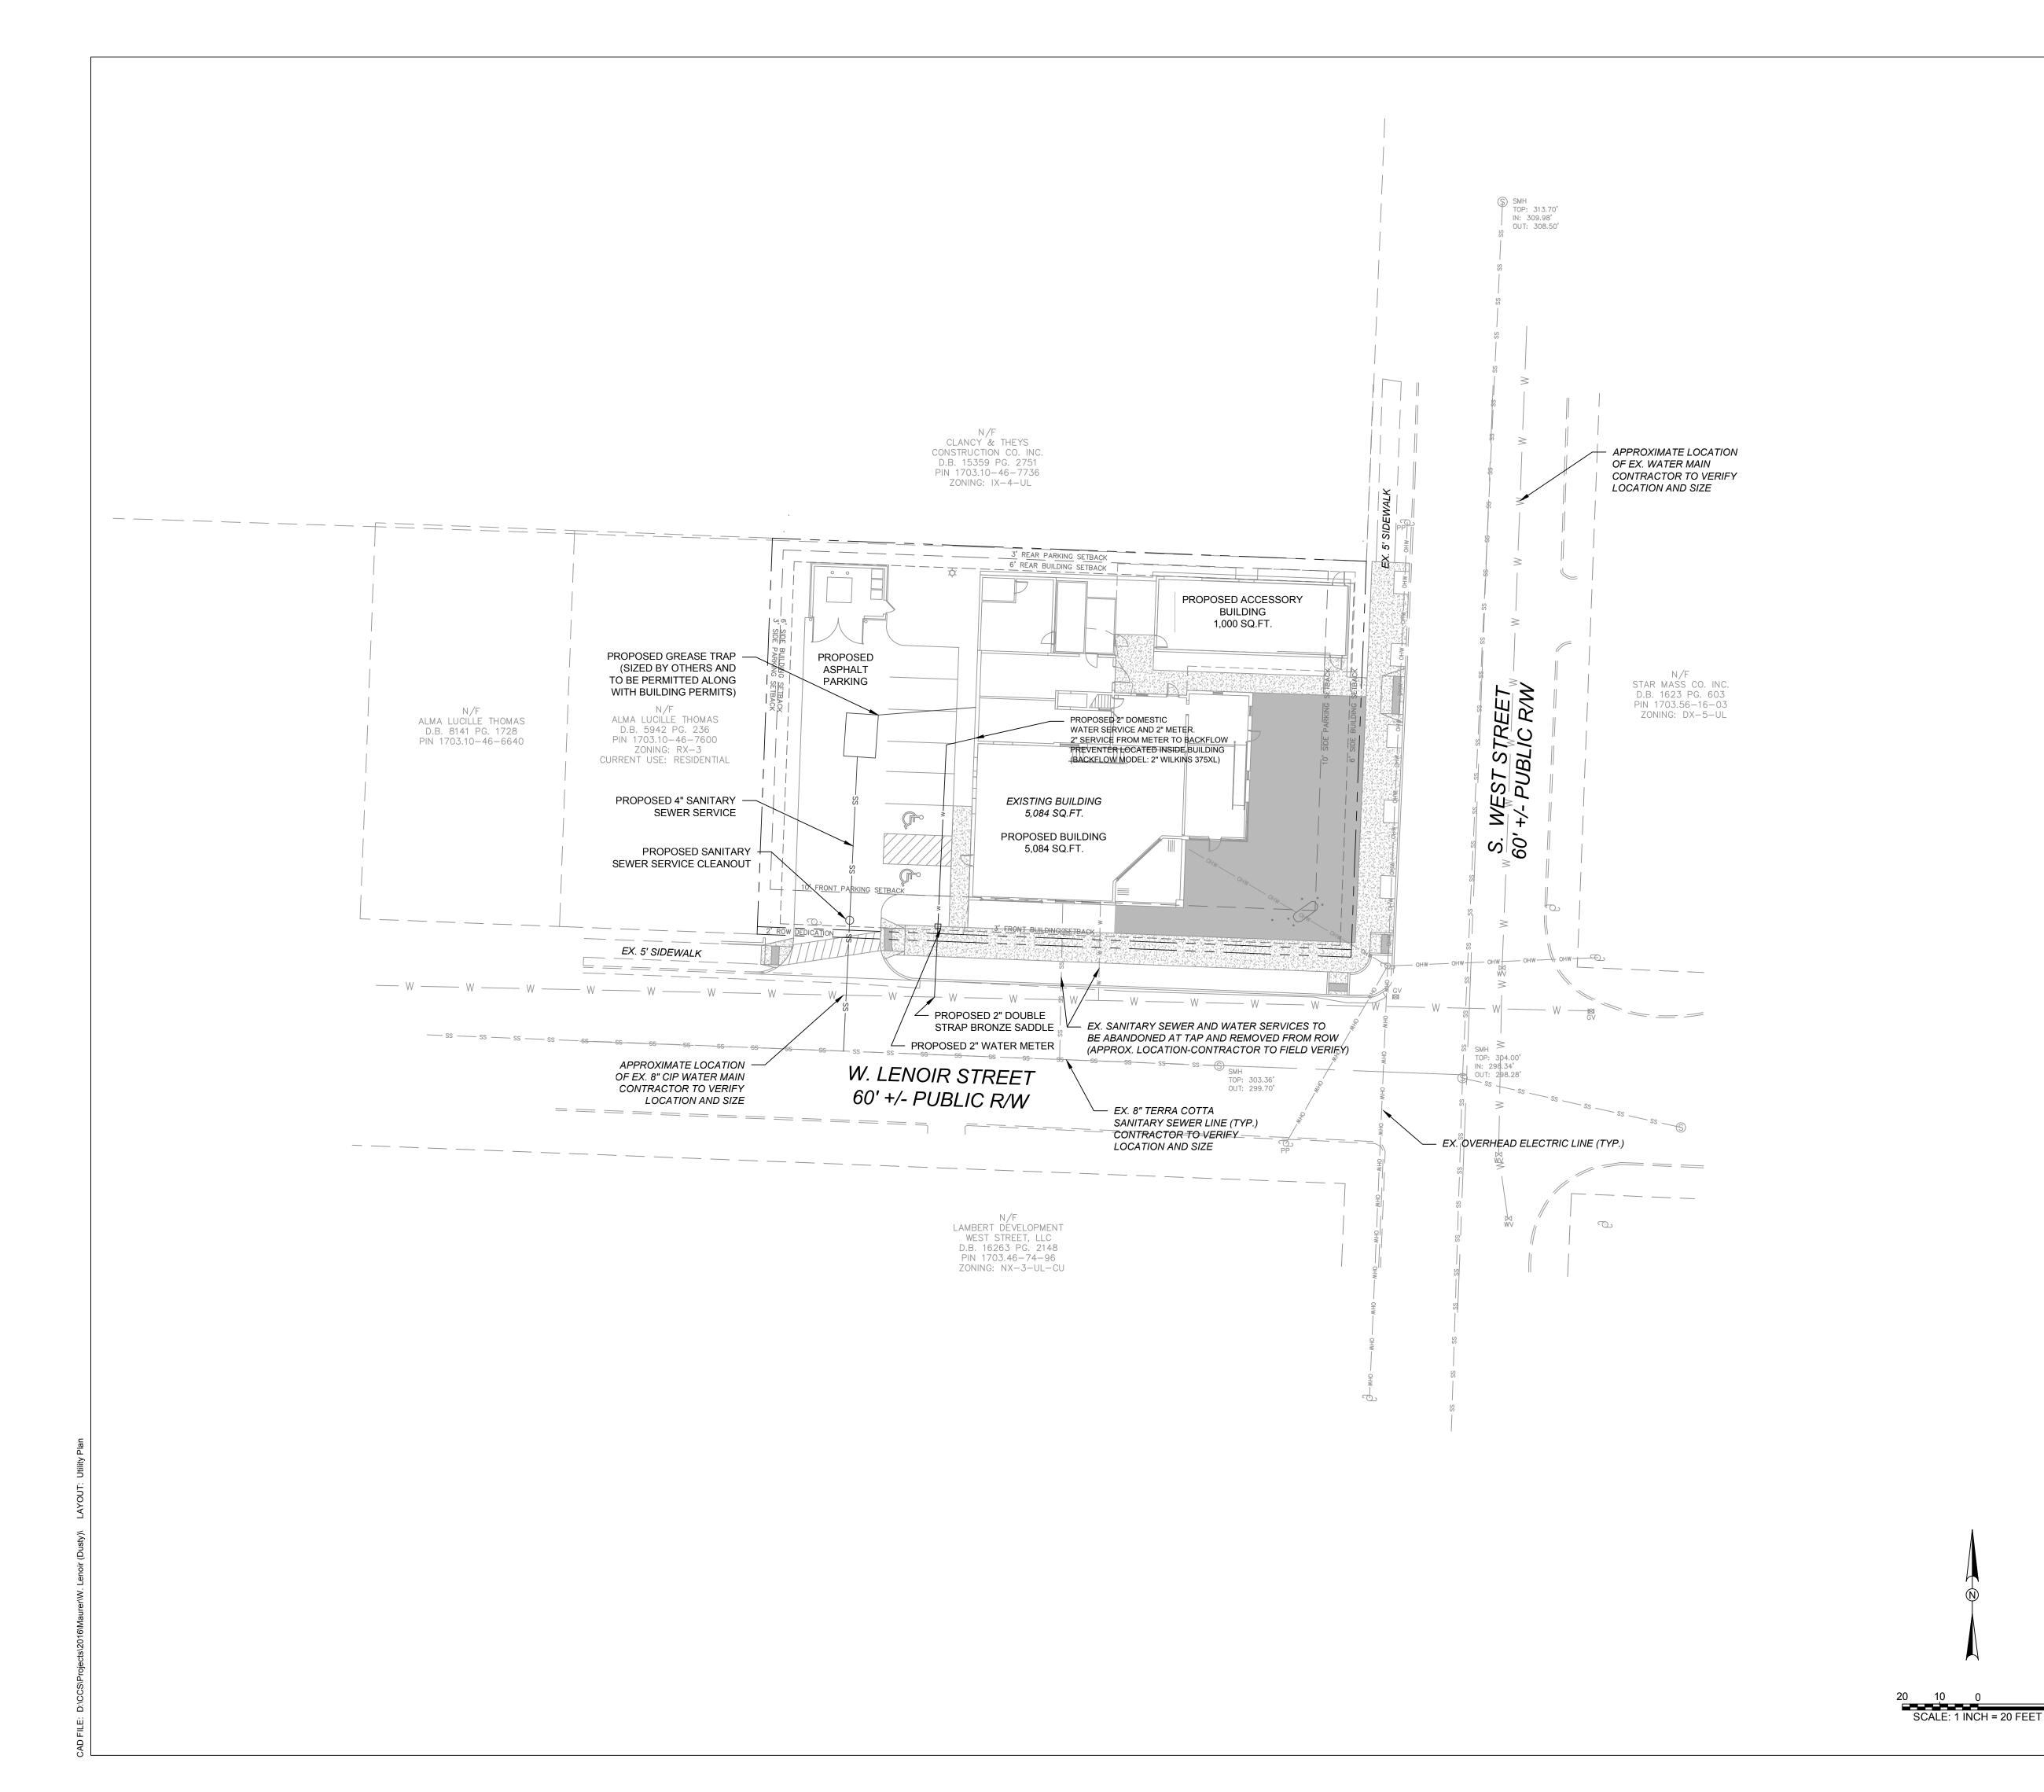


**LEGEND** 


—— — — — EXISTING PROPERTY LINE EXISTING ABUTTING PROPERTY LINE EXISTING RIGHT-OF-WAY —— OHW—— OHW—— OHW—— OHW—— OHW—— EXISTING OVERHEAD POWER LINE EXISTING ABUTTING PROPERTY LINE — — — — — — EXISTING BUILDING SETBACK LINE EXISTING PARKING SETBACK LINE ---- --- EXISTING EDGE OF PAVEMENT PROPOSED EDGE OF PAVEMENT

### **CITY OF RALEIGH UTILITY NOTES**

1. ALL MATERIALS & CONSTRUCTION METHODS SHALL BE IN ACCORDANCE WITH CITY OF RALEIGH DESIGN STANDARDS, DETAILS & SPECIFICATIONS (REFERENCE: CORPUD HANDBOOK, CURRENT EDITION)

- 2. UTILITY SEPARATION REQUIREMENTS:
- a. A DISTANCE OF 100' SHALL BE MAINTAINED BETWEEN SANITARY SEWER & ANY PRIVATE OR PUBLIC WATER SUPPLY SOURCE SUCH AS AN IMPOUNDED RESERVOIR USED AS A SOURCE OF DRINKING WATER. IF ADEQUATE LATERAL SEPARATION CANNOT BE ACHIEVED, FERROUS SANITARY SEWER PIPE SHALL BE SPECIFIED & INSTALLED TO WATERLINE SPECIFICATIONS. HOWEVER, THE MINIMUM SEPARATION SHALL NOT BE LESS THAN 25' FROM A PRIVATE WELL OR 50' FROM A PUBLIC WELL.
- b. WHEN INSTALLING WATER &OR SEWER MAINS, THE HORIZONTAL SEPARATION BETWEEN UTILITIES SHALL BE 10'. IF THIS SEPARATION CANNOT BE MAINTAINED DUE TO EXISTING CONDITIONS, THE VARIATION ALLOWED IS THE WATER MAIN IN A SEPARATE TRENCH WITH THE ELEVATION OF THE WATER MAIN AT LEAST 18" ABOVE THE TOP OF THE SEWER & MUST BE APPROVED BY THE PUBLIC UTILITIES DIRECTOR. ALL DISTANCES ARE MEASURED FROM OUTSIDE DIAMETER TO OUTSIDE DIAMETER. c. WHERE IT IS IMPOSSIBLE TO OBTAIN PROPER SEPARATION, OR
- ANYTIME A SANITARY SEWER PASSES OVER A WATERMAIN, DIP MATERIALS OR STEEL ENCASEMENT EXTENDED 10' ON EACH SIDE OF CROSSING MUST BE SPECIFIED & INSTALLED TO WATERLINE SPECIFICATIONS.
- d. 5.0' MINIMUM HORIZONTAL SEPARATION IS REQUIRED BETWEEN ALL SANITARY SEWER & STORM SEWER FACILITIES, UNLESS DIP
- MATERIAL IS SPECIFIED FOR SANITARY SEWER. e. MAINTAIN 18" MIN. VERTICAL SEPARATION AT ALL WATERMAIN & RCP STORM DRAIN
- CROSSINGS; MAINTAIN 24" MIN. VERTICAL SEPARATION AT ALL SANITARY SEWER & RCP STORM DRAIN CROSSINGS. WHERE ADEQUATE SEPARATIONS CANNOT BE ACHIEVED, SPECIFY DIP MATERIALS & A CONCRETE CRADLE HAVING 6" MIN. CLEARANCE (PER CORPUD DETAILS W-41 & S-49)
- f. ALL OTHER UNDERGROUND UTILITIES SHALL CROSS WATER & SEWER FACILITIES WITH 18" MIN. VERTICAL SEPARATION REQUIRED.
- 3. ANY NECESSARY FIELD REVISIONS ARE SUBJECT TO REVIEW & APPROVAL OF AN AMENDED PLAN &/OR PROFILE BY THE CITY OF RALEIGH PUBLIC UTILITIES DEPARTMENT PRIOR TO CONSTRUCTION.
- 4. CONTRACTOR SHALL MAINTAIN CONTINUOUS WATER & SEWER SERVICE TO EXISTING RESIDENCES & BUSINESSES THROUGHOUT CONSTRUCTION OF PROJECT. ANY NECESSARY SERVICE INTERRUPTIONS SHALL BE PRECEDED BY A 24 HOUR ADVANCE NOTICE TO THE CITY OF RALEIGH PUBLIC UTILITIES DEPARTMENT.
- 5. 3.0' MINIMUM COVER IS REQUIRED ON ALL WATER MAINS & SEWER FORCEMAINS. 4.0' MINIMUM COVER IS REQUIRED ON ALL REUSE MAINS.
- 6. ABANDON AND REMOVE EXISTING WATER AND SEWER SERVICES NOT BEING USED IN REDEVELOPMENT OF SITE AS DIRECTED BY THE CITY OF RALEIGH PUBLIC UTILITIES DEPARTMENT. THIS INCLUDES ABANDONING TAP AT MAIN & REMOVAL OF SERVICE FROM ROW OR EASEMENT PER CORPUD HANDBOOK PROCEDURE.
- 7. INSTALL 2" COPPER WATER SERVICES WITH METERS LOCATED AT ROW OR WITHIN A 2'X2' WATERLINE EASEMENT IMMEDIATELY ADJACENT. NOTE: IT IS THE APPLICANT'S RESPONSIBILITY TO PROPERLY SIZE THE WATER SERVICE FOR EACH CONNECTION TO PROVIDE ADEQUATE FLOW & PRESSURE.
- 8. INSTALL 4" PVC SEWER SERVICES @ 1.0% MINIMUM GRADE WITH CLEANOUTS LOCATED AT ROW OR EASEMENT LINE & SPACED EVERY 75 LINEAR FEET MAXIMUM.
- 9. PRESSURE REDUCING VALVES ARE REQUIRED ON ALL WATER SERVICES EXCEEDING 80 PSI; BACKWATER VALVES ARE REQUIRED ON ALL SANITARY SEWER SERVICES HAVING BUILDING DRAINS LOWER THAN 1.0' ABOVE THE NEXT UPSTREAM MANHOLE.
- 10. ALL ENVIRONMENTAL PERMITS APPLICABLE TO THE PROJECT MUST BE OBTAINED FROM NCDWQ, USACE &/OR FEMA FOR ANY RIPARIAN BUFFER, WETLAND &/OR FLOODPLAIN IMPACTS (RESPECTIVELY) PRIOR TO CONSTRUCTION.
- 11. NCDOT / RAILROAD ENCROACHMENT AGREEMENTS ARE REQUIRED FOR ANY UTILITY WORK (INCLUDING MAIN EXTENSIONS & SERVICE TAPS) WITHIN STATE OR RAILROAD ROW PRIOR TO CONSTRUCTION.
- 12. GREASE INTERCEPTOR / OIL WATER SEPARATOR SIZING CALCULATIONS & INSTALLATION SPECIFICATIONS SHALL BE APPROVED BY THE CORPUD FOG PROGRAM COORDINATOR PRIOR TO ISSUANCE OF A BUILDING PERMIT. CONTACT TIM BEASLEY AT (919) 996-2334 OR timothy.beasley@raleighnc.gov FOR MORE INFORMATION.
- 13. CROSS-CONNECTION CONTROL PROTECTION DEVICES ARE REQUIRED BASED ON DEGREE OF HEALTH HAZARD INVOLVED AS LISTED IN APPENDIX-B OF THE RULES GOVERNING PUBLIC WATER SYSTEMS IN NORTH CAROLINA. THESE GUIDELINES ARE THE MINIMUM REQUIREMENTS. THE DEVICES SHALL MEET AMERICAN SOCIETY OF SANITARY ENGINEERING (ASSE) STANDARDS OR BE ON THE UNIVERSITY OF SOUTHERN CALIFORNIA APPROVAL LIST. THE DEVICES SHALL BE INSTALLED AND TESTED (BOTH INITIAL AND PERIODIC TESTING THEREAFTER) IN ACCORDANCE WITH THE MANUFACTURER'S RECOMMENDATIONS OR THE LOCAL CROSS-CONNECTION CONTROL PROGRAM, WHICHEVER IS MORE STRINGENT. CONTACT JOANIE HARTLEY AT (919) 996-5923 OR joanie.hartley@raleighnc.goc FOR MORE INFORMATION

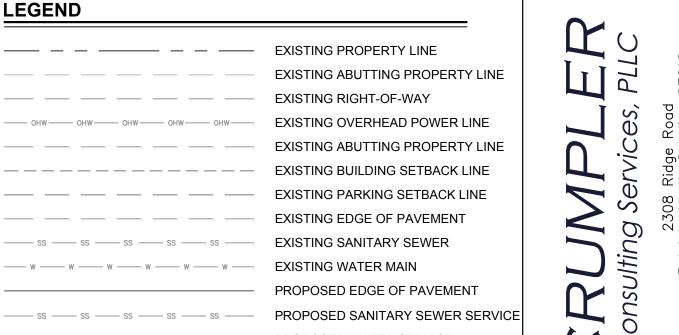

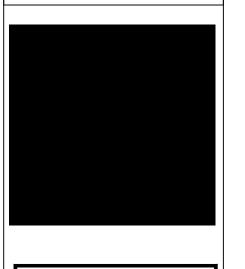

**ISSUED FOR** 

**PERMITTING** 


DATE			
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Ш STR LENOIR 502

PROJECT NO.: 501 DRAWN BY: JAC CHECKED BY: JAC 11/15/18

SCALE: 1" = 20'

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LALL SLOTS ARE 1/4" WIDE MAX.

MATERIAL: CAST GRAY IRON ASTM A-48, CLASS 35B

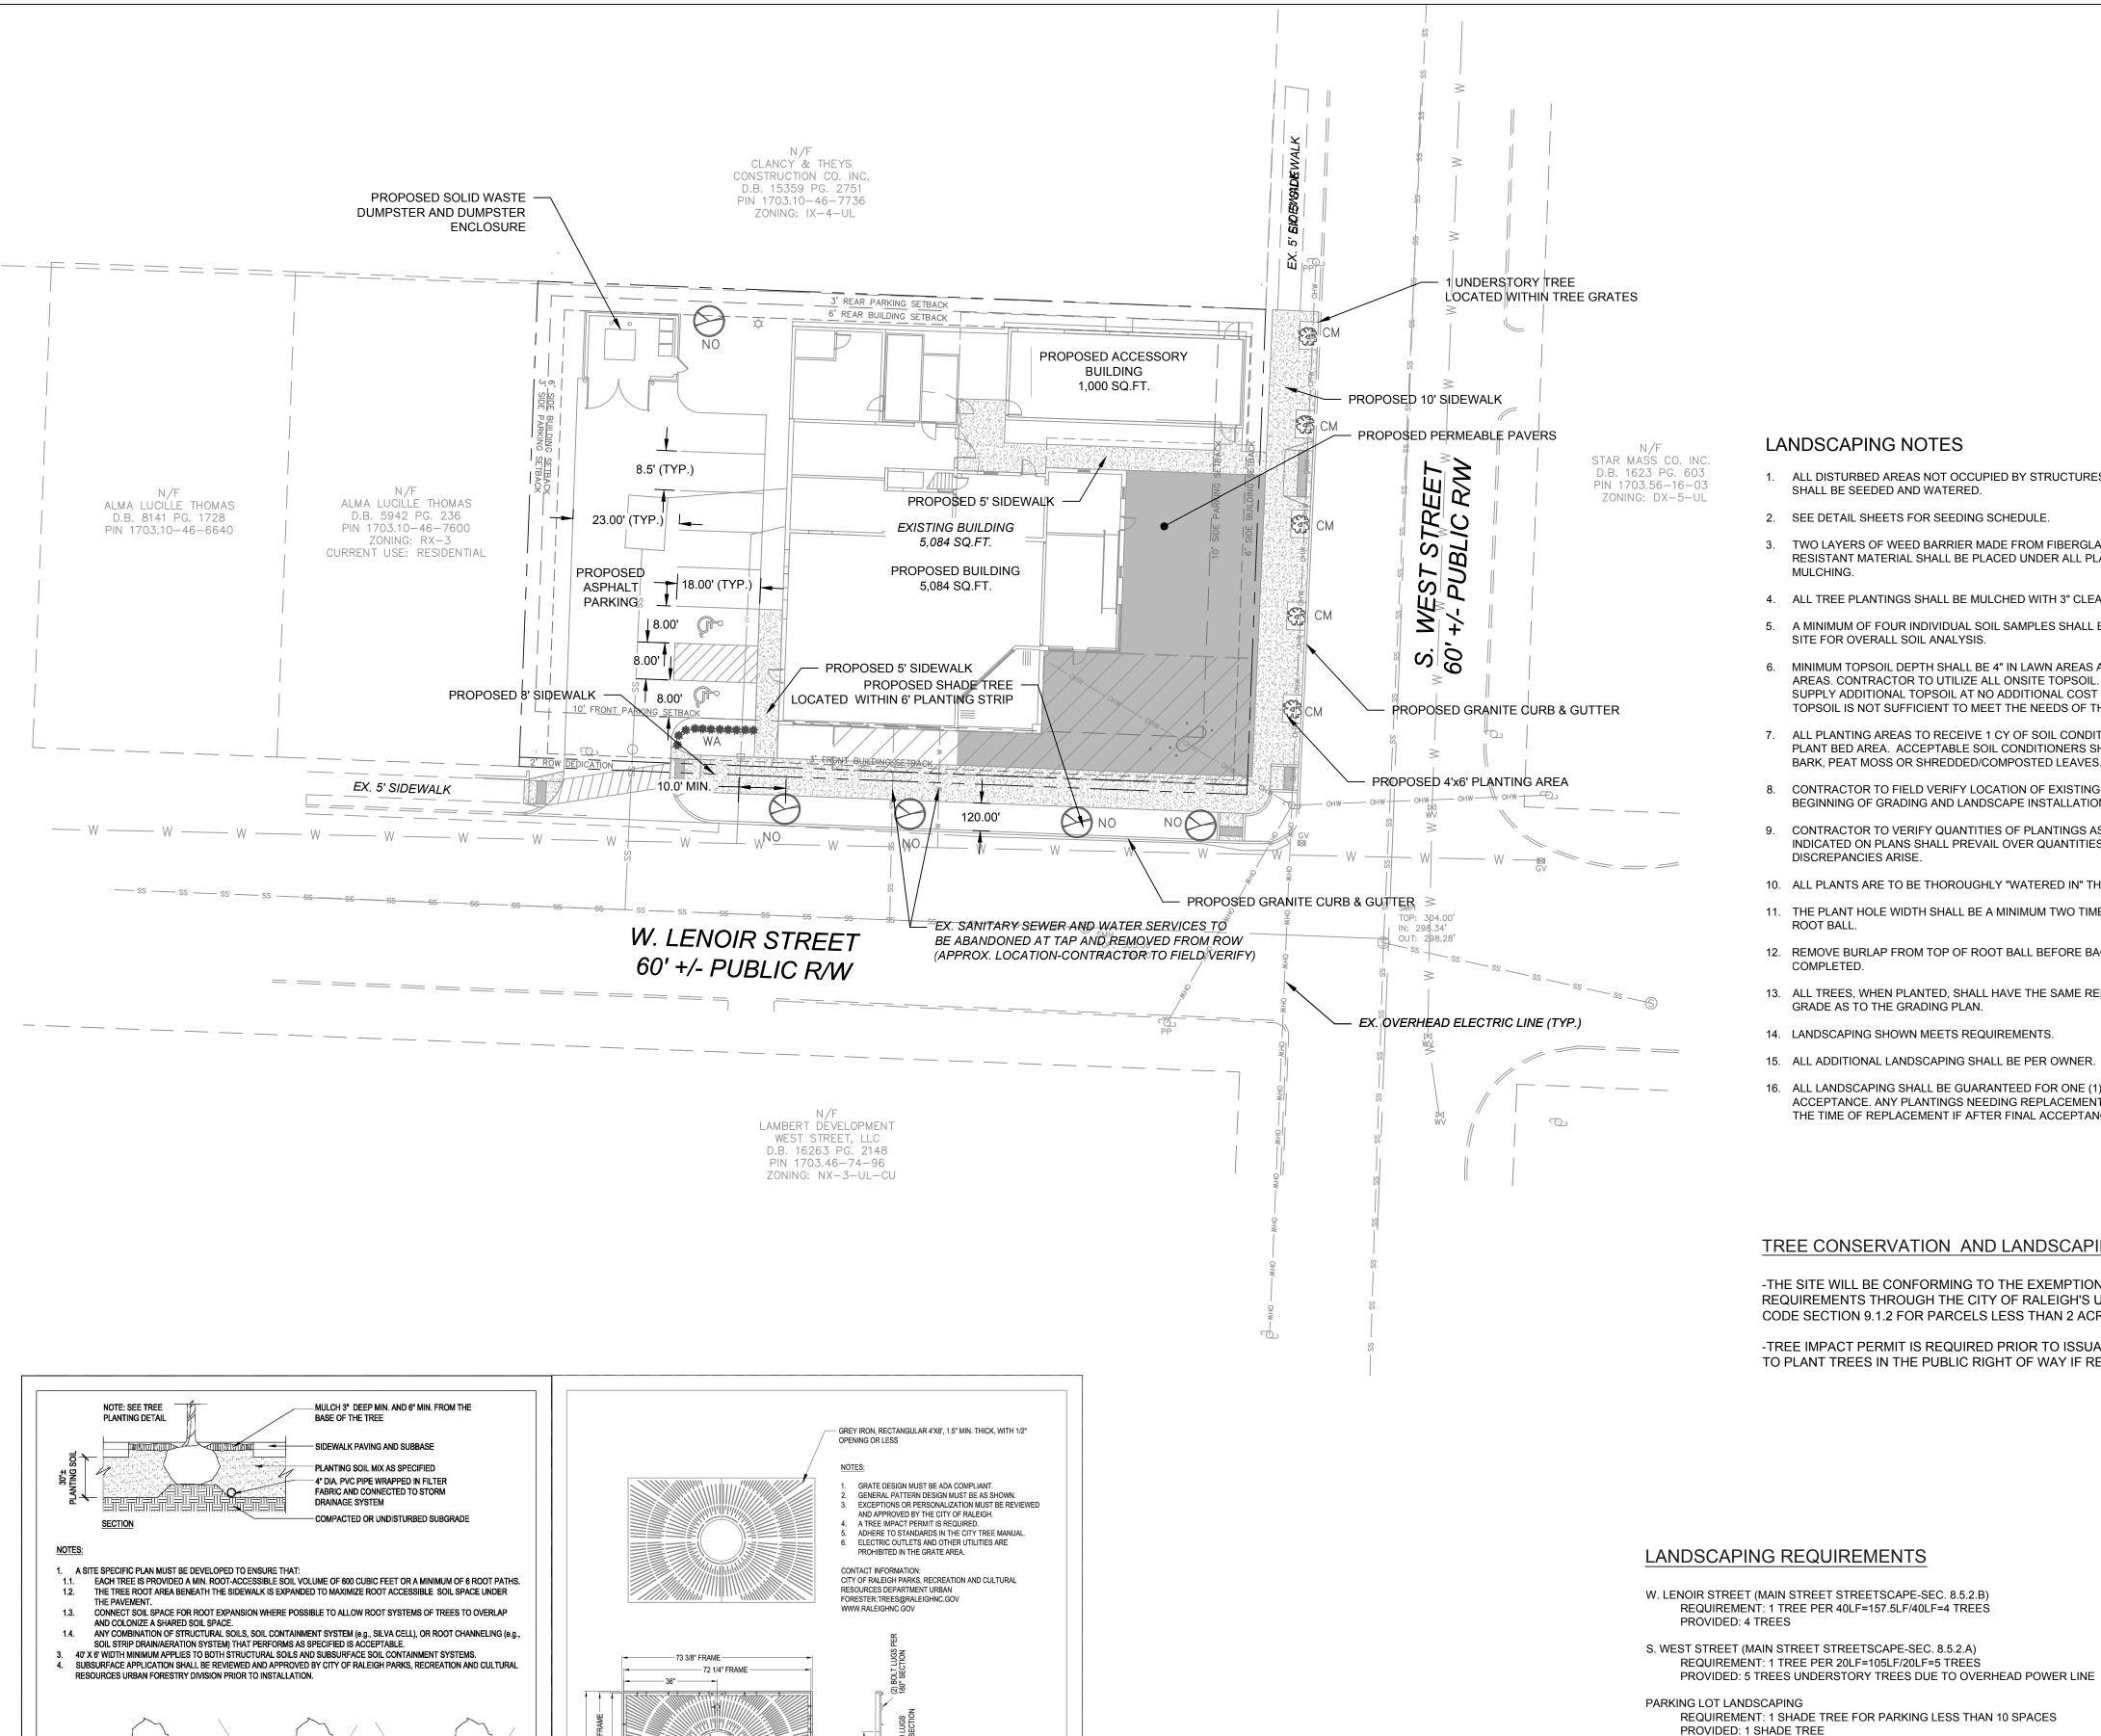BOLT TREE GRATE HALVES TOGETHER w/ (2) 1/2"-13 x 3" STNL. STL. HEX BOLTS, GALV. FLAT WASHERS AND STNL. STL. HEX NUT

BOLTED PLATE -

REVISIONS DATE: 9/1/13

TÁPPED HOLES

NOT TO SCAL

ASSEMBLY DETAIL

CITY OF RALEIGH

PARKS, RECREATION AND CULTURAL RESOURCES DEPT

SIDEWALK WITHIN ROW

PRCR-06

# LANDSCAPING NOTES

- 1. ALL DISTURBED AREAS NOT OCCUPIED BY STRUCTURES, PAVING OR PLANTINGS SHALL BE SEEDED AND WATERED.
- 2. SEE DETAIL SHEETS FOR SEEDING SCHEDULE.
- 3. TWO LAYERS OF WEED BARRIER MADE FROM FIBERGLASS AND ULTRA-VIOLET LIGHT RESISTANT MATERIAL SHALL BE PLACED UNDER ALL PLANTING BEDS PRIOR TO
- 4. ALL TREE PLANTINGS SHALL BE MULCHED WITH 3" CLEAN, BARK MULCH.
- SITE FOR OVERALL SOIL ANALYSIS.
- 6. MINIMUM TOPSOIL DEPTH SHALL BE 4" IN LAWN AREAS AND 12" IN LANDSCAPED AREAS. CONTRACTOR TO UTILIZE ALL ONSITE TOPSOIL. CONTRACTOR SHALL SUPPLY ADDITIONAL TOPSOIL AT NO ADDITIONAL COST TO OWNER IF EXISTING TOPSOIL IS NOT SUFFICIENT TO MEET THE NEEDS OF THIS PROJECT.
- 7. ALL PLANTING AREAS TO RECEIVE 1 CY OF SOIL CONDITIONER FOR EACH 75 SF OF PLANT BED AREA. ACCEPTABLE SOIL CONDITIONERS SHALL BE PULVERIZED PINE BARK, PEAT MOSS OR SHREDDED/COMPOSTED LEAVES.
- 8. CONTRACTOR TO FIELD VERIFY LOCATION OF EXISTING UTILITIES BEFORE BEGINNING OF GRADING AND LANDSCAPE INSTALLATION.
- 9. CONTRACTOR TO VERIFY QUANTITIES OF PLANTINGS AS SHOWN. PLANTINGS INDICATED ON PLANS SHALL PREVAIL OVER QUANTITIES INDICATED IN PLANT LIST IF DISCREPANCIES ARISE.
- 10. ALL PLANTS ARE TO BE THOROUGHLY "WATERED IN" THE SAME DAY AS PLANTED.
- 11. THE PLANT HOLE WIDTH SHALL BE A MINIMUM TWO TIMES THE DIAMETER OF THE ROOT BALL.
- 12. REMOVE BURLAP FROM TOP OF ROOT BALL BEFORE BACKFILLING AROUND BALL IS
- 13. ALL TREES, WHEN PLANTED, SHALL HAVE THE SAME RELATIONSHIP TO FINISHED GRADE AS TO THE GRADING PLAN.
- 14. LANDSCAPING SHOWN MEETS REQUIREMENTS.

TYPE 'C-3' STREETYARD BUFFER

PROVIDED: 11 SHRUBS

REQUIREMENT: 30 SHRUBS PER 100LF

- 15. ALL ADDITIONAL LANDSCAPING SHALL BE PER OWNER.
- 16 ALL LANDSCAPING SHALL BE GUARANTEED FOR ONE (1) YEAR AFTER FINAL ACCEPTANCE. ANY PLANTINGS NEEDING REPLACEMENT WILL BE GUARANTEED FROM THE TIME OF REPLACEMENT IF AFTER FINAL ACCEPTANCE.

### TREE CONSERVATION AND LANDSCAPING NOTES:

-THE SITE WILL BE CONFORMING TO THE EXEMPTION OF TREE CONSERVATION REQUIREMENTS THROUGH THE CITY OF RALEIGH'S UNIFIED DEVELOPMENT CODE SECTION 9.1.2 FOR PARCELS LESS THAN 2 ACRES IN SIZE.

-TREE IMPACT PERMIT IS REQUIRED PRIOR TO ISSUANCE OF BUILDING PERMIT TO PLANT TREES IN THE PUBLIC RIGHT OF WAY IF REQUIRED.

### PLANTING REQUIREMENTS

1.1 GENERAL PRODUCT REQUIREMENTS A. PROVIDE A STRUCTURAL PLANTING SOIL USING THE TWO COMPONENTS LISTED BELOW THAT

MEET ASTM STANDARDS AS FOLLOWS: 1. 3/4" EXPANDED SLATE 80%

LEGEND

- 2. SANDY CLAY LOAM 20% 3. PERCENTAGES OF SAND AND CLAY MAY VARY TO MEET TEST REQUIREMENTS. B. COMPACTION: WHEN CALCULATING THE VOLUME NECESSARY FOR THE PROJECT, ADD
- APPROXIMATELY 18% TO THE CALCULATED VOLUME TO ALLOW FOR COMPACTION WHICH OCCURS DURING INSTALLATION DUE TO DRIVING SMALL EQUIPMENT OVER THE PRODUCT, IN ADDITION TO THE NATURAL SETTLING PROCESS.

—— — — — EXISTING PROPERTY LINE

— OHW—— OHW—— OHW—— OHW—— OHW—— EXISTING OVERHEAD POWER LINE

EXISTING ABUTTING PROPERTY LINE

EXISTING ABUTTING PROPERTY LINE

EXISTING BUILDING SETBACK LINE

EXISTING PARKING SETBACK LINE

EXISTING EDGE OF PAVEMENT

PROPOSED EDGE OF PAVEMENT

PROPOSED PERMEABLE PAVERS

PROPOSED CONCRETE SIDEWALK

PROPOSED OUTDOOR AMENITY AREA

EXISTING SANITARY SEWER

EXISTING RIGHT-OF-WAY

- 5. A MINIMUM OF FOUR INDIVIDUAL SOIL SAMPLES SHALL BE TAKEN THROUGHOUT THE 1.2 STRUCTURAL SOIL COMPONENTS: A. SIZE 3/4" ROTARY KILN EXPANDED SLATE
  - 1. ONLY NON-HAZARDOUS FUELS SUCH AS COAL OR NATURAL GAS MAY BE USED TO PROCESS
  - 2. UNIT DRY WEIGHT LOOSE: 48 LB./C.F. TO 55 LB./C.F. (ASTM C29)(SATURATED SURFACE LOOSE: 55 LBS./C.F. TO 60 LBS./C.F.)
  - 3. SPECIFIC GRAVITY: 1.45 TO 1.60, DRY BULK (ASTM C127) 4. GRADATION: 3/4" - #4 SIZE
    - SIEVE SIZE % PASSING
  - 10-50
  - 5. TEST FOR DEGRADATION LOSS USING LOS ANGELES ABRASION TESTING IN ACCORDANCE WITH ASTM C-131 MODIFIED METHOD FM 1-T096. NO MORE THAN 28% OF THE WEIGHT OF THE AGGREGATE MUST BE LOST TO DEGRADATION.
  - B. SANDY CLAY LOAM: SANDY CLAY LOAM IS FOR MIXING WITH STRUCTURAL SOIL ONLY AND NOT TO BE CONFUSED
  - WITH "PLANTING SOIL TEXTURE:
  - 40 65% SAND 15 - 25% SILT
  - 20 35% CLAY 2 - 5 % ORGANIC MATTER
  - 3.0 PREPARATION:

DENSITY.

- 1. STRUCTURAL SOIL IS SHOWN IN A PUBLIC RIGHT-OF-WAY OR EASEMENT. OBTAIN APPROVALS FROM PROPER AUTHORITIES BEFORE AND AFTER PLACING STRUCTURAL SOIL 2. ACHIEVE 90% OF MAXIMUM DRY DENSITY FOR THE SUBGRADE. (ASTM D698)
- B. PREPARING SUBGRADE:
- 1. THE SUBGRADE SHALL BE PREPARED ACCORDING TO THE FOLLOWING PROCEDURE: REMOVE ALL ORGANIC MATTER, DEBRIS, LOOSE MATERIAL AND LARGE ROCKS.
- 2. DIG OUT SOFT AND MUCKY SPOTS AND REPLACE WITH SUITABLE MATERIAL. 3. LOOSEN HARD SPOTS; UNIFORMLY COMPACT SUBGRADE TO 95% OF ITS MAXIMUM DRY
- C. PERFORATED UNDERDRAIN SYSTEM (IF USED): 1. INSTALL UNDER DRAIN SYSTEM, WITH SOCK OR SOIL SEPARATOR FABRIC, ACCORDING TO
- DRAWINGS AND CONNECTED TO STORM DRAIN.

### 3.3 INSTALLATION OF STRUCTURAL SOIL MIX: A. GENERAL:


- 1. INSTALL THE SOIL DRAINS ENSURING THE STRUCTURAL SOIL IS PROPERLY COMPACTED UNDER AND AROUND EACH PIPE.
- 2. CONSIDER USING ROOT BARRIERS IF IT IS DESIRED TO AVOID ROOT PENETRATION INTO
- ADJACENT UTILITIES. B. PLACING AND COMPACTING STRUCTURAL SOIL:
- 1. PLACE STRUCTURAL SOIL MIX IN HORIZONTAL LIFTS NOT EXCEEDING 12 INCHES DEPTH. COMPACT USING A VIBRATORY PLATE COMPACTING MACHINE. PERFORM A MINIMUM OF TWO PASSES, OF NOT LESS THAN 10 SECONDS PER PASS, BEFORE MOVING THE VIBRATORY PLATE TO THE NEXT ADJACENT LOCATION. ADDITIONAL PASSES MAY BE REQUIRED SHOULD THE FIELD ENGINEER DETERMINE ADDITIONAL COMPACTION IS NECESSARY TO INSURE STABILITY OF THE LAYER. CONTINUE PLACING AND COMPACTING 12 INCH LIFTS UNTIL THE
- SPECIFIED DEPTH IS REACHED. 2. FOR LARGE SPACES, A VIBRATORY STEEL ROLLER WEIGHING NO MORE THAN 12 TONS STATIC WEIGHT CAN BE USED. HORIZONTAL LIFTS SHOULD NOT EXCEED 12 INCHES COMPACTED. THE MINIMUM NUMBER OF PASSES IS TWO AND MAXIMUM NUMBER IS FOUR. ADDITIONAL PASSES MAY BE REQUIRED SHOULD THE FIELD ENGINEER DETERMINE

ADDITIONAL COMPACTION IS NECESSARY TO INSURE STABILITY OF THE LAYER.

### 3.5 TREE PIT PREPARATION:

- A. TREE PIT EXCAVATION: 1. EXCAVATE THE TREE PIT USING THE FOLLOWING PROCEDURE:
  - a. EXCAVATE THE STRUCTURAL SOIL MIX TO A DEPTH EQUAL TO THE HEIGHT OF THE ROOT BALL OF THE TREE TO BE PLANTED. REMOVE THE STRUCTURAL SOIL TO WITHIN NO MORE THAN ONE FOOT OF THE EDGE OF THE PAVED AREA.
  - b. PLACE THE TREE IN THE PIT AND BACKFILL AS DESCRIBED BELOW AS SOON AS POSSIBLE.
  - c. NO TREE PIT SHALL REMAIN EXCAVATED FOR MORE THAN 2 HOURS UNLESS FORMS ARE USED.
- B. TREE PIT BACKFILL PLANTING MIX:
  - BACKFILL TREE PIT USING THE FOLLOWING PROCEDURE: a. REMOVE ANY WOODEN FORMS. IMMEDIATELY PLACE THE TREE IN THE PIT AS DETAILED
- AND REPLACE THE EXCAVATED STRUCTURAL SOIL WITH EITHER OF THE FOLLOWING: b. PLANTING SOIL FOR TREES AS SPECIFIED
- c. HAND TAMP THE PLANTING MIX IN 12 INCH LIFTS UNTIL THE PIT IS FILLED TO THE SPECIFIED GRADE.
- d. DO NOT USE EXCAVATED SOIL AS ENGINEERED FILL TO SUPPORT PAVING OR
- STRUCTURES. EXCESS EXCAVATED STRUCTURAL SOIL MIX MAY BE USED FOR OTHER PLANTING BACKFILL OPERATIONS.

KEY	QUA.	BOTANICAL NAME	COMMON NAME	HEIGHT	SPREAD	ROOT	CALIPER
		UNDERSTORY TREES					
СМ	5	LAGERSTROEMIA SPP., L HYBRIDS	SINGLE STEM CREPE MYRTLE	6'		B&B	2"
			"COMANCHE"				
		SHADE TREES					
NO	5	QUERCUS NUTTALLII	NUTTALL OAK	10'		B&B	3"
		SHRUBS					
WA	11	RHODODENDRON PERICLYMENOIDES	WILD AZALEA	18"		5 GAL.	

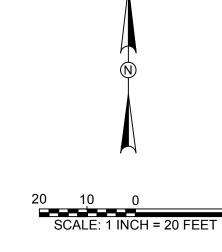

PROJECT NO.: 501 DRAWN BY: JAC CHECKED BY: JAC 11/15/18 1" = 20' SCALE:

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**ISSUED FOR** 

**PERMITTING** 



STRUCTURAL SOIL SYSTEM

CONTACT INFORMATION:

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SOIL CONTAINMENT SYSTEM

CITY OF RALEIGH PARKS, RECREATION AND CULTURAL RESOURCES DEPARTMENT

ROOT CHANNELING/PATHWAYS

METHOD NOT USE

CITY OF RALEIGH

ARKS, RECREATION AND CULTURAL RESOURCES DEP

SIDEWALK WITHIN R.O.W

PRCR-07


PROPOSED ELEVATIONS

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PROPOSED ELEVATIONS

A2.3



DR.

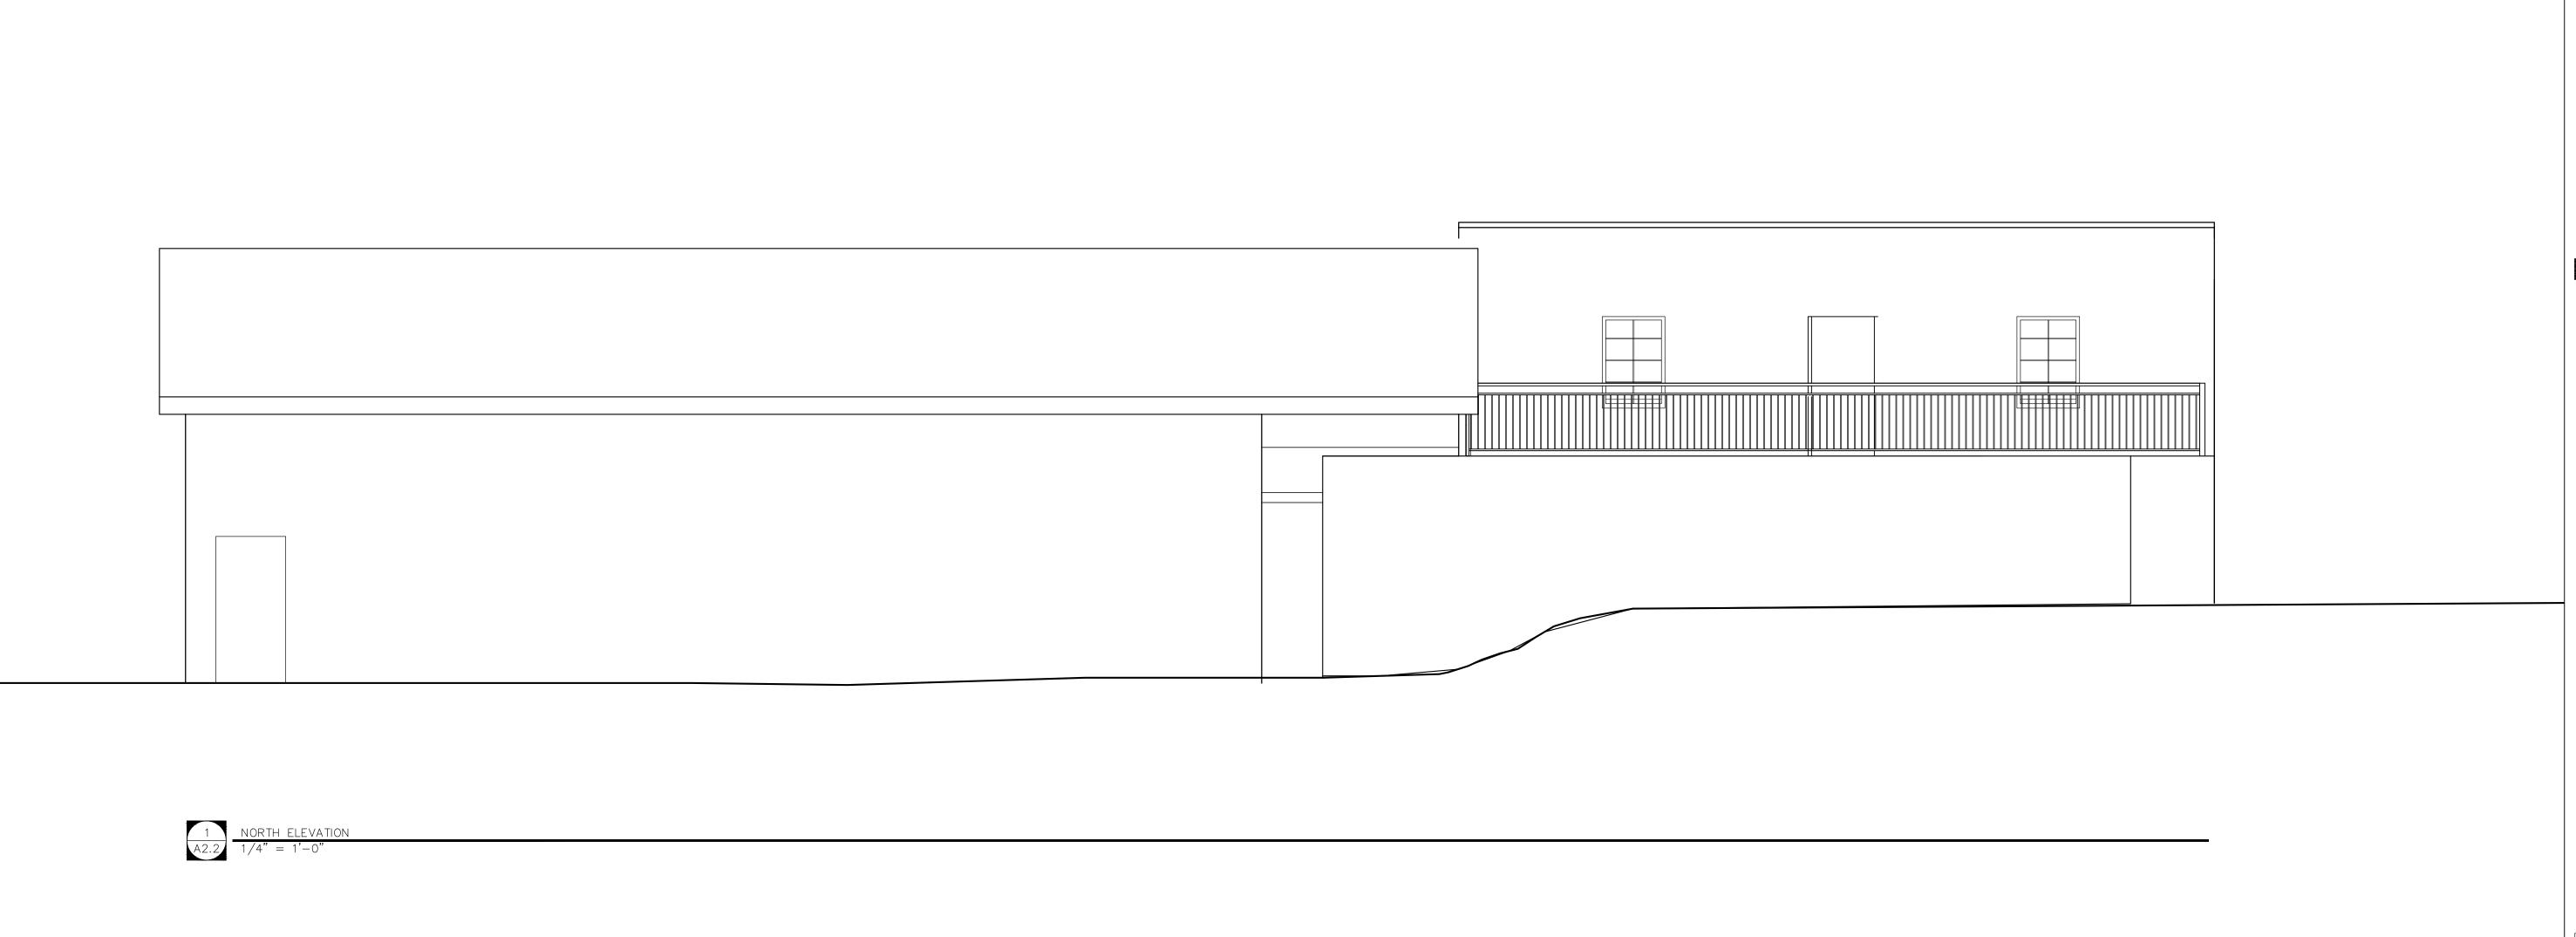CH.